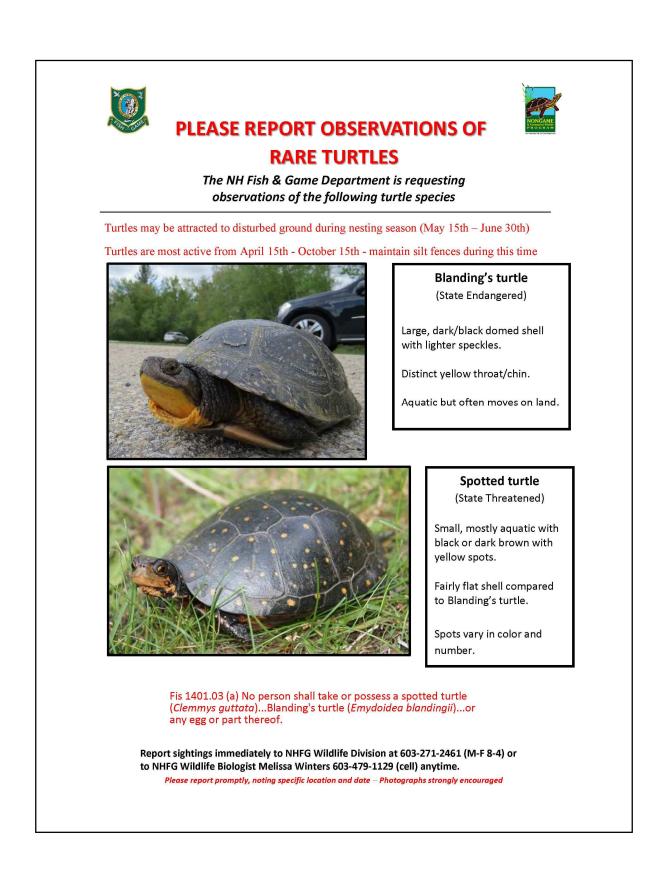
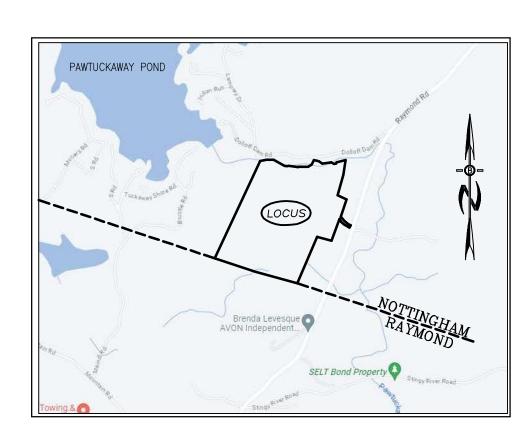
PAWTUCKAWAY RIDGE SUBDIVISION RAYMOND ROAD (RT 156) TAX MAP 69, LOT 17





LOCATION MAP

OWNER:
THE FORGOTTEN MTN REALTY TRUST
DAVID SANDERSON TRUSTEE
33 HOBBS ROAD
NORTH HAMPTON, NH 03862

APPLICANT/DEVELOPER:

JOSEPH FALZONE

7B EMERY LANE

STRATHAM, N.H. 03885

INDEX TITLE SHEET LOT LINE ADJUSTMENT PLAN 1 of 1 SUBDIVISION PLANS TOPOGRAPHIC PLANS SUBDIVISION YIELD PLAN 15 - 17SUBDIVISION SITE PLAN ROADWAY ACCESS PLANS 18 - 18A19 - 21ROAD PLAN & PROFILES DRAINAGE BASIN PLANS CONSTRUCTION DETAIL PLANS 24 - 2526 EROSION & SEDIMENT CONTROL DETAILS ROAD CROSS SECTIONS 27 - 32

TOWN NOTES

IF, DURING CONSTRUCTION, IT BECOMES APPARENT THAT DEFICIENCIES EXIST IN THE APPROVED DESIGN DRAWINGS, THE CONTRACTOR SHALL BE REQUIRED TO CORRECT THE DEFICIENCIES TO MEET THE REQUIREMENTS OF THE REGULATIONS AT NO EXPENSE TO THE TOWN.

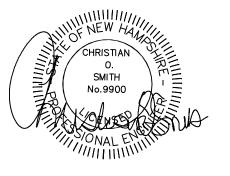
REQUIRED EROSION CONTROL MEASURES SHALL BE INSTALLED PRIOR TO ANY DISTURBANCE OF THE SITE. SURFACE AREA SHALL BE MAINTAINED THROUGH THE COMPLETION OF ALL CONSTRUCTION ACTIVITIES, IF, DURING CONSTRUCTION, IT BECOMES APPARENT THAT ADDITIONAL EROSION CONTROL MEASURES ARE REQUIRED TO STOP ANY EROSION ON THE CONSTRUCTION SITE DUE TO ACTUAL SITE CONDITIONS, THE OWNER SHALL BE REQUIRED TO INSTALL THE NECESSARY EROSION PROTECTION AT NO EXPENSE TO THE TOWN.

ALL MATERIALS AND METHODS OF CONSTRUCTION SHALL CONFORM TO TOWN OF NOTTINGHAM SUBDIVISION REGULATIONS AND THE LATEST EDITION OF NEW HAMPSHIRE DEPARTMENT OF TRANSPORTATION STANDARD SPECIFICATIONS FOR ROAD & BRIDGE CONSTRUCTION.

CIVIL ENGINEERS:



70 PORTSMOUTH AVE, THIRD FLOOR, SUITE 2 STRATHAM, N.H. 03885 PHONE: 603-583-4860, FAX. 603-583-4863




LAND SURVEYORS:



WETLAND / SOIL CONSULTANT:

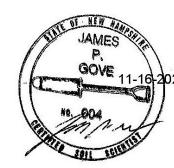GOVE ENVIRONMENTAL SERVICES INC.
8 CONTINENTAL DRIVE,
BLDG 2 UNIT H
EXETER, NH 03833
1-603-778-0644




REQUIRED PERMITS

NHDOT DRIVEWAY PERMIT#: 06-351-389

NHDES SUBDIVISION APPROVAL NUMBER: eSA2024.....


NHDES ALTERATION OF TERRAIN APPROVAL NUMBER: 2023.....

REVISIONS:	DATE:
REVISED LOTS	2-1-24
REVISED PER REVIEW	3-12-24

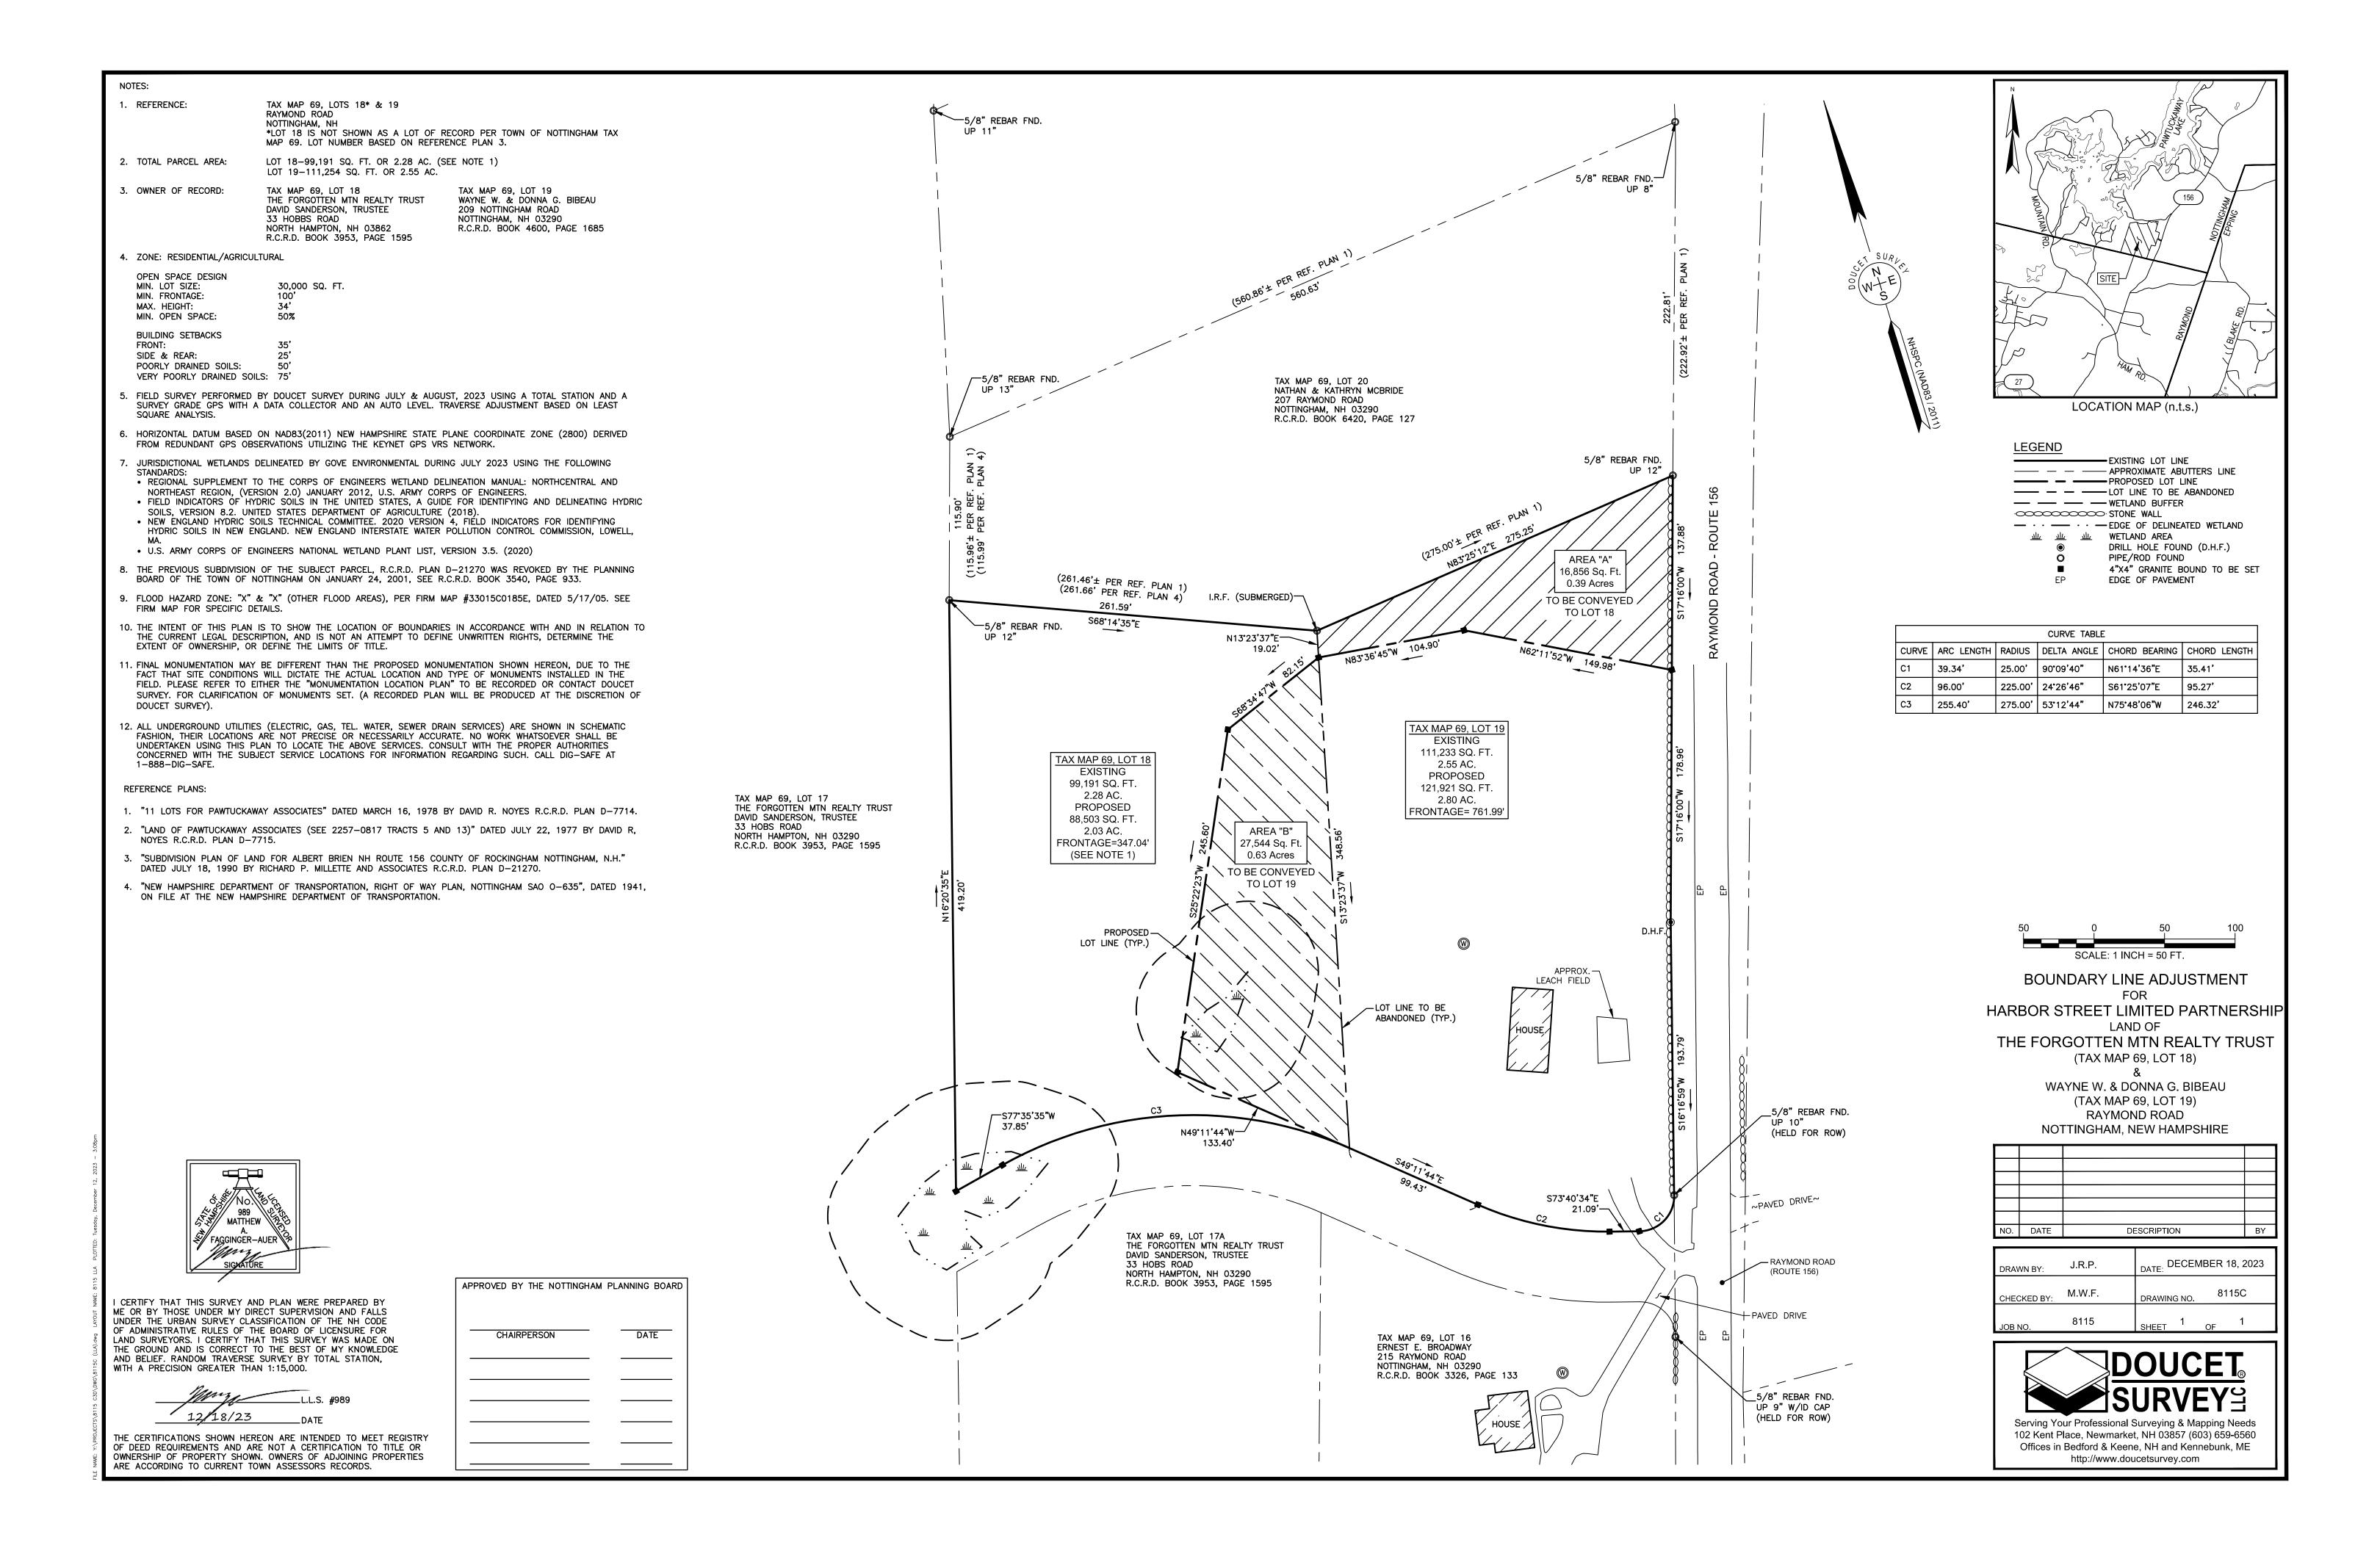

I. REFERENCE: TAX MAP 69, LOTS 17, 17A* & 18* RAYMOND ROAD *LOTS 17A & 18 ARE NOT SHOWN AS LOTS OF RECORD PER TOWN OF NOTTINGHAM 2. TOTAL PARCEL AREA: LOT 17-3,717,170 SQ. FT.± OR 85.33 AC.± (AREA CALCULATED TO EDGE OF RIVER) LOT 17A-126,844 SQ. FT. OR 2.91 AC. (SEE NOTE #1) LOT 18-99,191 SQ. FT. OR 2.28 AC. (SEE NOTE #1) 3. OWNER OF RECORD: TAX MAP 69, LOTS 17, 17A & 18 THE FORGOTTEN MTN REALTY TRUST DAVID SANDERSON, TRUSTEE 33 HOBBS ROAD NORTH HAMPTON, NH 03862 R.C.R.D. BOOK 3953, PAGE 1595 4. ZONE: RESIDENTIAL/AGRICULTURAL OPEN SPACE DESIGN MIN. LOT SIZE: 30,000 SQ. FT. MIN. FRONTAGE: MAX. HEIGHT: MIN. OPEN SPACE: 50% BUILDING SETBACKS POORLY DRAINED SOILS: VERY POORLY DRAINED SOILS: 75' . FIELD SURVEY PERFORMED BY DOUCET SURVEY DURING JULY & AUGUST, 2023 USING A TOTAL STATION AND A SURVEY GRADE GPS WITH A DATA COLLECTOR AND AN AUTO LEVEL. TRAVERSE ADJUSTMENT BASED ON LEAST 6. AERIAL TOPOGRAPHY WAS CONDUCTED BY EASTERN TOPOGRAPHICS FROM IMAGES TAKEN DURING APRIL 2005 WITH A PHOTO SCALE OF 1"=400'. CONTOURS AND OBJECTS SHOWN WITHIN OBSCURED AREAS ARE APPROXIMATE AND SHOULD BE VERIFIED BEFORE USE FOR DESIGN OR CONSTRUCTION PURPOSES. HORIZONTAL DATUM BASED ON NAD83(2011) NEW HAMPSHIRE STATE PLANE COORDINATE ZONE (2800) DERIVED FROM REDUNDANT GPS OBSERVATIONS UTILIZING THE KEYNET GPS VRS NETWORK. B. VERTICAL DATUM IS BASED ON APPROXIMATE NAVD88(GEOID18) $(\pm .2')$ DERIVED FROM REDUNDANT GPS OBSERVATIONS UTILIZING THE KEYNET GPS VRS NETWORK. JURISDICTIONAL WETLANDS DELINEATED BY GOVE ENVIRONMENTAL DURING JULY 2023 USING THE FOLLOWING • REGIONAL SUPPLEMENT TO THE CORPS OF ENGINEERS WETLAND DELINEATION MANUAL: NORTHCENTRAL AND NORTHEAST REGION, (VERSION 2.0) JANUARY 2012, U.S. ARMY CORPS OF ENGINEERS. FIELD INDICATORS OF HYDRIC SOILS IN THE UNITED STATES, A GUIDE FOR IDENTIFYING AND DELINEATING HYDRIC SOILS, VERSION 8.2. UNITED STATES DEPARTMENT OF AGRICULTURE (2018).

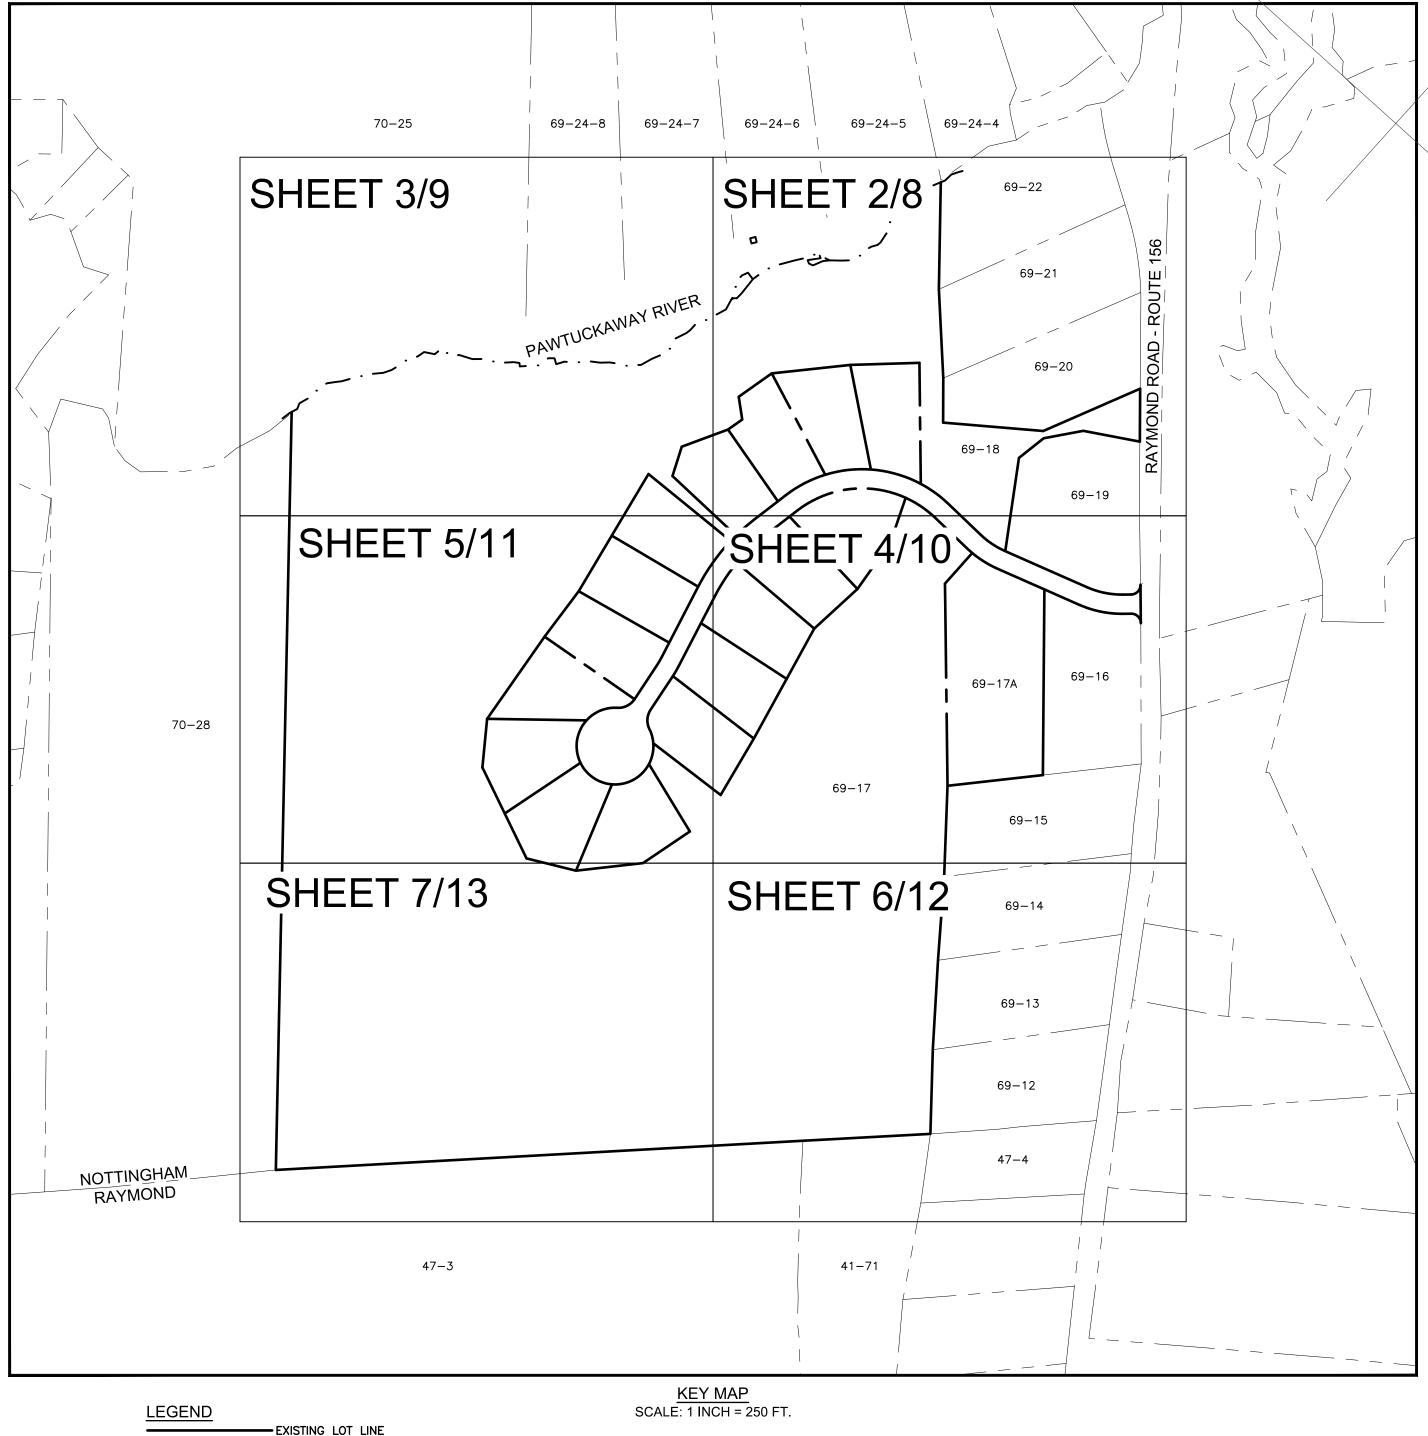• NEW ENGLAND HYDRIC SOILS TECHNICAL COMMITTEE. 2020 VERSION 4, FIELD INDICATORS FOR IDENTIFYING HYDRIC SOILS IN NEW ENGLAND. NEW ENGLAND INTERSTATE WATER POLLUTION CONTROL COMMISSION, LOWELL, • U.S. ARMY CORPS OF ENGINEERS NATIONAL WETLAND PLANT LIST, VERSION 3.5. (2020) 10. THE PREVIOUS SUBDIVISION OF THE SUBJECT PARCEL, R.C.R.D. PLAN D-21270 WAS REVOKED BY THE PLANNING BOARD OF THE TOWN OF NOTTINGHAM ON JANUARY 24, 2001, SEE R.C.R.D. BOOK 3540, PAGE 933. 11. FLOOD HAZARD ZONE: "X" & "X" (OTHER FLOOD AREAS), PER FIRM MAP #33015C0185E, DATED 5/17/05. SEE FIRM MAP FOR SPECIFIC DETAILS. 12. PROPER FIELD PROCEDURES WERE FOLLOWED IN ORDER TO GENERATE CONTOURS AT 2' INTERVALS. ANY MODIFICATION OF THIS INTERVAL WILL DIMINISH THE INTEGRITY OF THE DATA, AND DOUCET SURVEY WILL NOT BE RESPONSIBLE FOR ANY SUCH ALTERATION PERFORMED BY THE USER. 13. THE INTENT OF THIS PLAN IS TO SHOW THE LOCATION OF BOUNDARIES IN ACCORDANCE WITH AND IN RELATION TO THE CURRENT LEGAL DESCRIPTION, AND IS NOT AN ATTEMPT TO DEFINE UNWRITTEN RIGHTS, DETERMINE THE EXTENT OF OWNERSHIP, OR DEFINE THE LIMITS OF TITLE. 14. WATER BOUNDARIES ARE DYNAMIC IN NATURE AND ARE SUBJECT TO CHANGE DUE TO NATURAL CAUSES SUCH AS 15. FINAL MONUMENTATION MAY BE DIFFERENT THAN THE PROPOSED MONUMENTATION SHOWN HEREON, DUE TO THE FACT THAT SITE CONDITIONS WILL DICTATE THE ACTUAL LOCATION AND TYPE OF MONUMENTS INSTALLED IN THE FIELD. PLEASE REFER TO EITHER THE "MONUMENTATION LOCATION PLAN" TO BE RECORDED OR CONTACT DOUCET SURVEY. FOR CLARIFICATION OF MONUMENTS SET. (A RECORDED PLAN WILL BE PRODUCED AT THE DISCRETION OF ALL LINDERGROUND LITHLITIES (FLECTRIC GAS TEL WATER SEWER DRAIN SERVICES) ARE SHOWN IN SCHEMATIC FASHION, THEIR LOCATIONS ARE NOT PRECISE OR NECESSARILY ACCURATE. NO WORK WHATSOEVER SHALL BE UNDERTAKEN USING THIS PLAN TO LOCATE THE ABOVE SERVICES. CONSULT WITH THE PROPER AUTHORITIES CONCERNED WITH THE SUBJECT SERVICE LOCATIONS FOR INFORMATION REGARDING SUCH. CALL DIG-SAFE AT 17. TOWN LINE PERAMBULATION AND ORIGINAL TOWN LINE MONUMENTS WERE UNABLE TO BE LOCATED BY CONTACTING THE TOWNS OF NOTTINGHAM AND RAYMOND. REFERENCE PLANS: 1. "11 LOTS FOR PAWTUCKAWAY ASSOCIATES" DATED MARCH 16, 1978 BY DAVID R. NOYES R.C.R.D. PLAN D-7714. 2. "LAND OF PAWTUCKAWAY ASSOCIATES (SEE 2257-0817 TRACTS 5 AND 13)" DATED JULY 22, 1977 BY DAVID R, NOYES R.C.R.D. PLAN D-7715. 3. "SUBDIVISION OF LAND FOR GARY & LEANN BERTRAM IN NOTTINGHAM, N.H." DATED MAY 15, 1985 BY SEACOAST ENGINEERING ASSOCIATES, INC. R.C.R.D. PLAN D-13859. 4. "SUBDIVISION PLAN OF LAND FOR ALBERT BRIEN NH ROUTE 156 COUNTY OF ROCKINGHAM NOTTINGHAM. N.H." DATED JULY 18, 1990 BY RICHARD P. MILLETTE AND ASSOCIATES R.C.R.D. PLAN D-21270. 5. "A SURVEY AND PLAT OF PROPERTY PREPARED FOR THE ESTATE OF FOREST DEARBORN SITUATED ON ROUTE 156 IN THE TOWN OF RAYMOND, N.H." DATED JUNE 23, 1992 BY R.S.L. LAYOUT & DESIGN, INC. R.C.R.D. PLAN 6. "A SURVEY AND PLAT OF A SUBDIVISION PREPARED FOR COLE FAMILY TRUST SITUATED IN THE TOWN OF RAYMOND, N.H." DATED MAY 23, 1994 BY R.S.L. LAYOUT & DESIGN, INC. R.C.R.D. PLAN D-22986. 7. "PHASE TWO OF A SURVEY AND PLAT OF A SUBDIVISION PREPARED FOR THE COLE FAMILY TRUST SITUATED IN THE TOWN OF RAYMOND, N.H." DATED MARCH 29, 1995 BY R.S.L. LAYOUT & DESIGN, INC. R.C.R.D. PLAN D-24051. 8. "PHASE III OF A SURVEY AND PLAT OF A SUBDIVISION PREPARED FOR THE COLE FAMILY TRUST SITUATED IN THE TOWN OF RAYMOND, NH" DATED MARCH 27, 2000 BY R.S.L. LAYOUT & DESIGN, INC. R.C.R.D. PLAN D-30291. 9. "NEW HAMPSHIRE DEPARTMENT OF TRANSPORTATION, RIGHT OF WAY PLAN, NOTTINGHAM SAO 0-635", DATED 1941, ON FILE AT THE NEW HAMPSHIRE DEPARTMENT OF TRANSPORTATION.



—— — — APPROXIMATE ABUTTERS LINE

— · · — EDGE OF DELINEATED WETLAND

DRILL HOLE FOUND (D.H.F.)

4"X4" GRANITE BOUND TO BE SET

PIPE/ROD FOUND

TEST PIT LOCATION

UTILITY POLE EDGE OF PAVEMENT

PROPOSED LOT LINE
PROPOSED EASEMENT LINE
LOT LINE TO BE ABANDONED
BUILDING SETBACK LINE

— — WETLAND BUFFER

— — — — — PERIMETER BUFFER

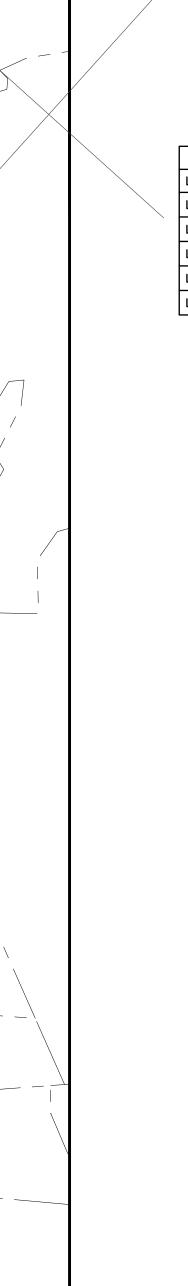
— · — · — EDGE OF WATER

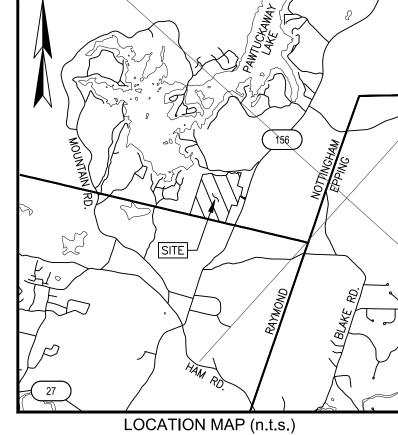
<u> யடிய</u> WETLAND AREA

LEDGE OUTCROP

· STONE WALL

—— – —— STREAM





LINE TABLE				
LINE	BEARING	DISTANCE		
L1	N29*11'18"W	32.98'		
L2	S69*19'56"W	26.46'		
L3	N69*19'56"E	25.95'		
L4	N73°40'34"W	20.84'		
L5	S73°40'34"E	21.09'		

CURVE TABLE					
CURVE	ARC LENGTH	RADIUS	DELTA ANGLE	CHORD BEARING	CHORD LENGTH
C1	117.33'	275.00	24*26'46"	S61°25'07"E	116.45'
C2	18.22'	275.00'	3*47'44"	S31°05'10"E	18.21'
С3	93.31'	275.00'	19*26'30"	N38*54'33"W	92.87'
C4	104.62'	475.00'	12*37'12"	S63*01'20"W	104.41'
C5	102.52'	475.00'	12*21'59"	S50°31'44"W	102.32'
C6	29.50'	275.00	6*08'49"	N47*25'09"E	29.49'
C7	52.36'	50.00'	60°00'00"	S20°29'33"W	50.00'
C8	38.72'	100.00'	22*11'04"	N01*35'05"E	38.48'
С9	56.27'	100.00'	32'14'33"	N28°47'54"E	55.53'
C10	116.28'	100.00'	66*37'29"	N78*13'55"E	109.84'
C11	103.96'	100.00'	59*33'59"	S38*40'21"E	99.34'
C12	118.73'	100.00'	68*01'28"	S25*07'23"W	111.87'
C13	89.64'	100.00'	51*21'27"	S84°48'50"W	86.66'
C14	52.36'	50.00'	60°00'00"	N80°29'33"E	50.00'
C15	24.14'	225.00'	6*08'49"	N47*25'09"E	24.13'
C16	146.58'	525.00'	15*59'48"	S52*20'39"W	146.10'
C17	20.01'	525.00'	2*11'00"	S61°26'03"W	20.01'
C18	62.37'	525.00'	6*48'23"	S65*55'45"W	62.33'
C19	116.44'	325.00'	20'31'41"	S79*35'46"W	115.82'
C20	120.20'	325.00'	21'11'29"	N79*32'39"W	119.52'
C21	73.59'	325.00'	12*58'25"	N38°26'58"W	73.43'
C22	15.74'	325.00'	2*46'28"	N30°34'32"W	15.74'
C23	78.57'	225.00'	20'00'26"	S39*11'31"E	78.17'
C24	96.00'	225.00'	24*26'46"	S61°25'07"E	95.27'
C25	39.34'	25.00'	90'09'40"	N61°14'36"E	35.41'
C26	39.27'	25.00'	90'00'01"	N28°40'34"W	35.36'
C27	136.20'	325.00'	24'00'44"	N56*56'33"W	135.21'
C28	297.76'	275.00'	62*02'15"	N79*38'56"W	283.43'

275.00' | 16'12'41"

APPROVED BY THE NOTTINGHAM PLANNING BOARD

DATE

CHAIRPERSON

SUBDIVISION PLAN

S41°05'23"E

HARBOR STREET LIMITED PARTNERSHIP

THE FORGOTTEN MTN REALTY TRUST
(TAX MAP 69, LOTS 17, 17A & 18)
RAYMOND ROAD

RAYMOND ROAD NOTTINGHAM, NEW HAMPSHIRE

2	03/12/24	REVISIONS PER REVIEW COMMENTS	MWF
1	01/17/24	REVISED SUBDIVISION DESIGN	MWI
NO.	DATE	DESCRIPTION	BY


DRAWN BY:	J.R.P.	DATE: DECEMBER 18, 2023	
CHECKED BY:	M.W.F.	DRAWING NO. 8115D	
JOB NO.	8115	SHEET 1 OF 13	



102 Kent Place, Newmarket, NH 03857 (603) 659-6560

Offices in Bedford & Keene, NH and Kennebunk, ME

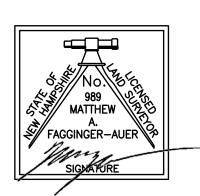
http://www.doucetsurvey.com





I CERTIFY THAT THIS SURVEY AND PLAN WERE PREPARED BY ME OR BY THOSE UNDER MY DIRECT SUPERVISION AND FALLS UNDER THE URBAN SURVEY CLASSIFICATION OF THE NH CODE OF ADMINISTRATIVE RULES OF THE BOARD OF LICENSURE FOR LAND SURVEYORS. I CERTIFY THAT THIS SURVEY WAS MADE ON THE GROUND AND IS CORRECT TO THE BEST OF MY KNOWLEDGE AND BELIEF. RANDOM TRAVERSE SURVEY BY TOTAL STATION, WITH A PRECISION GREATER THAN 1:15,000.


L.L.S. #989 3/12/24 DATE

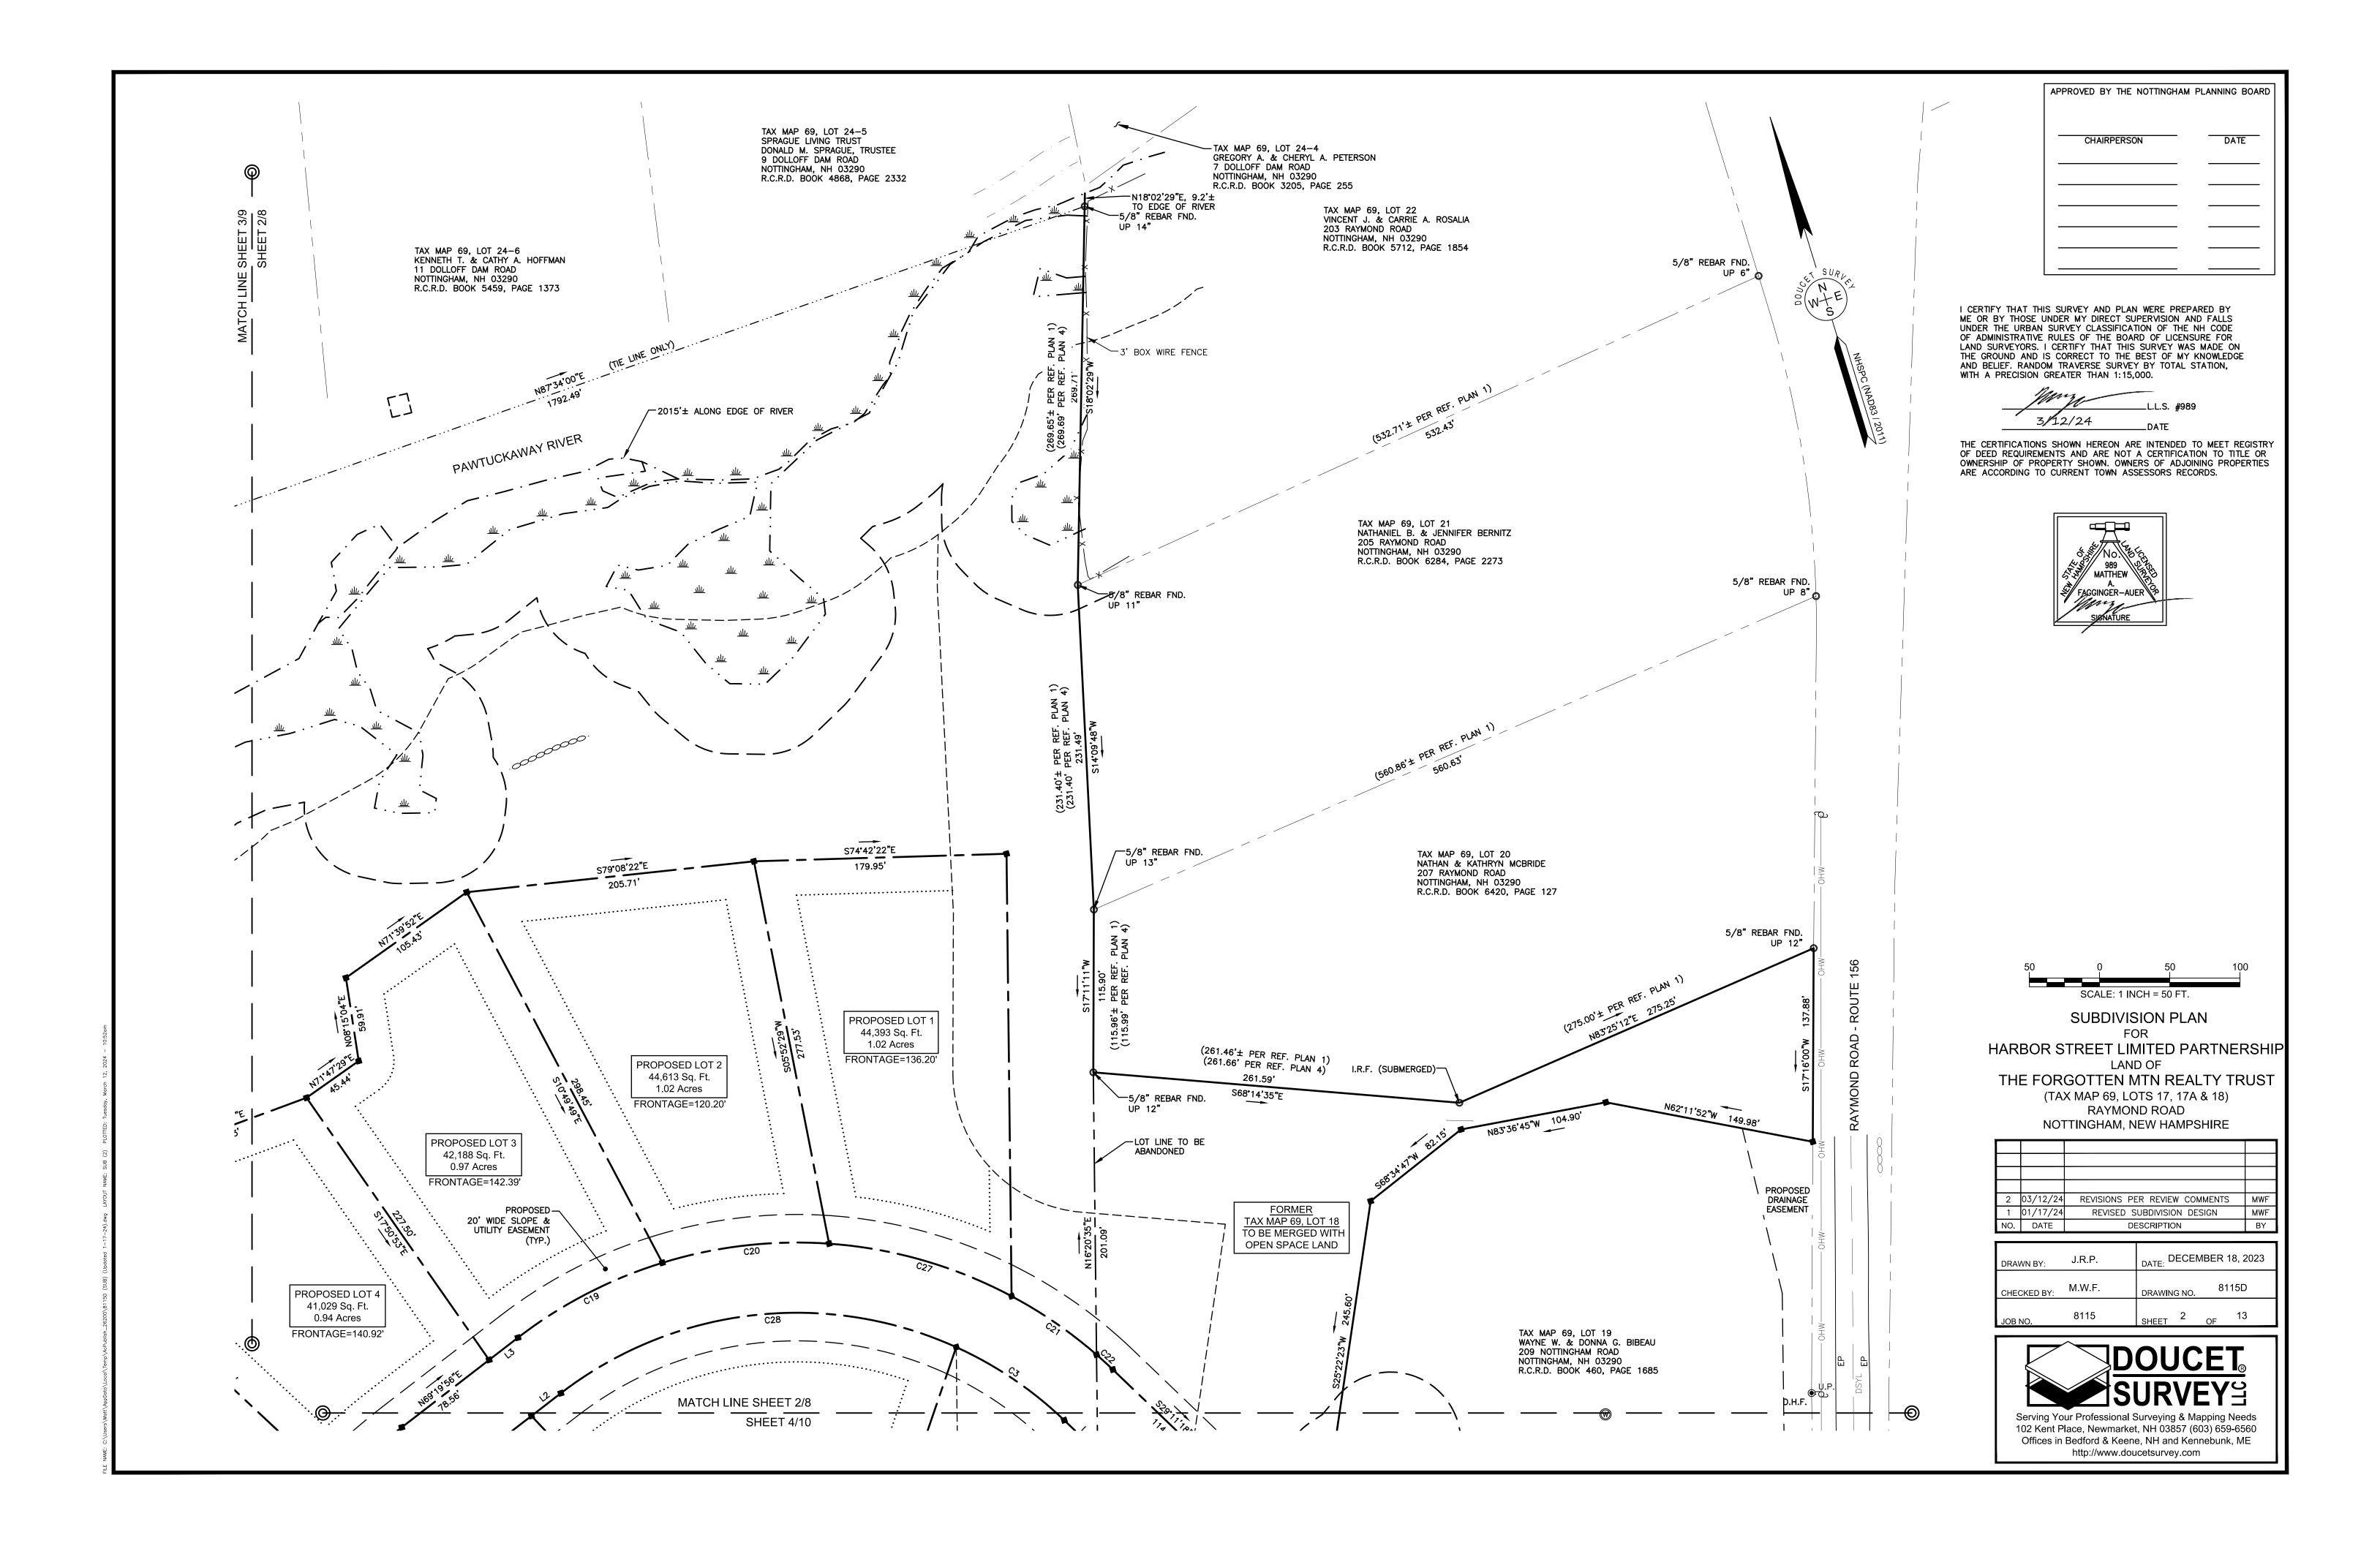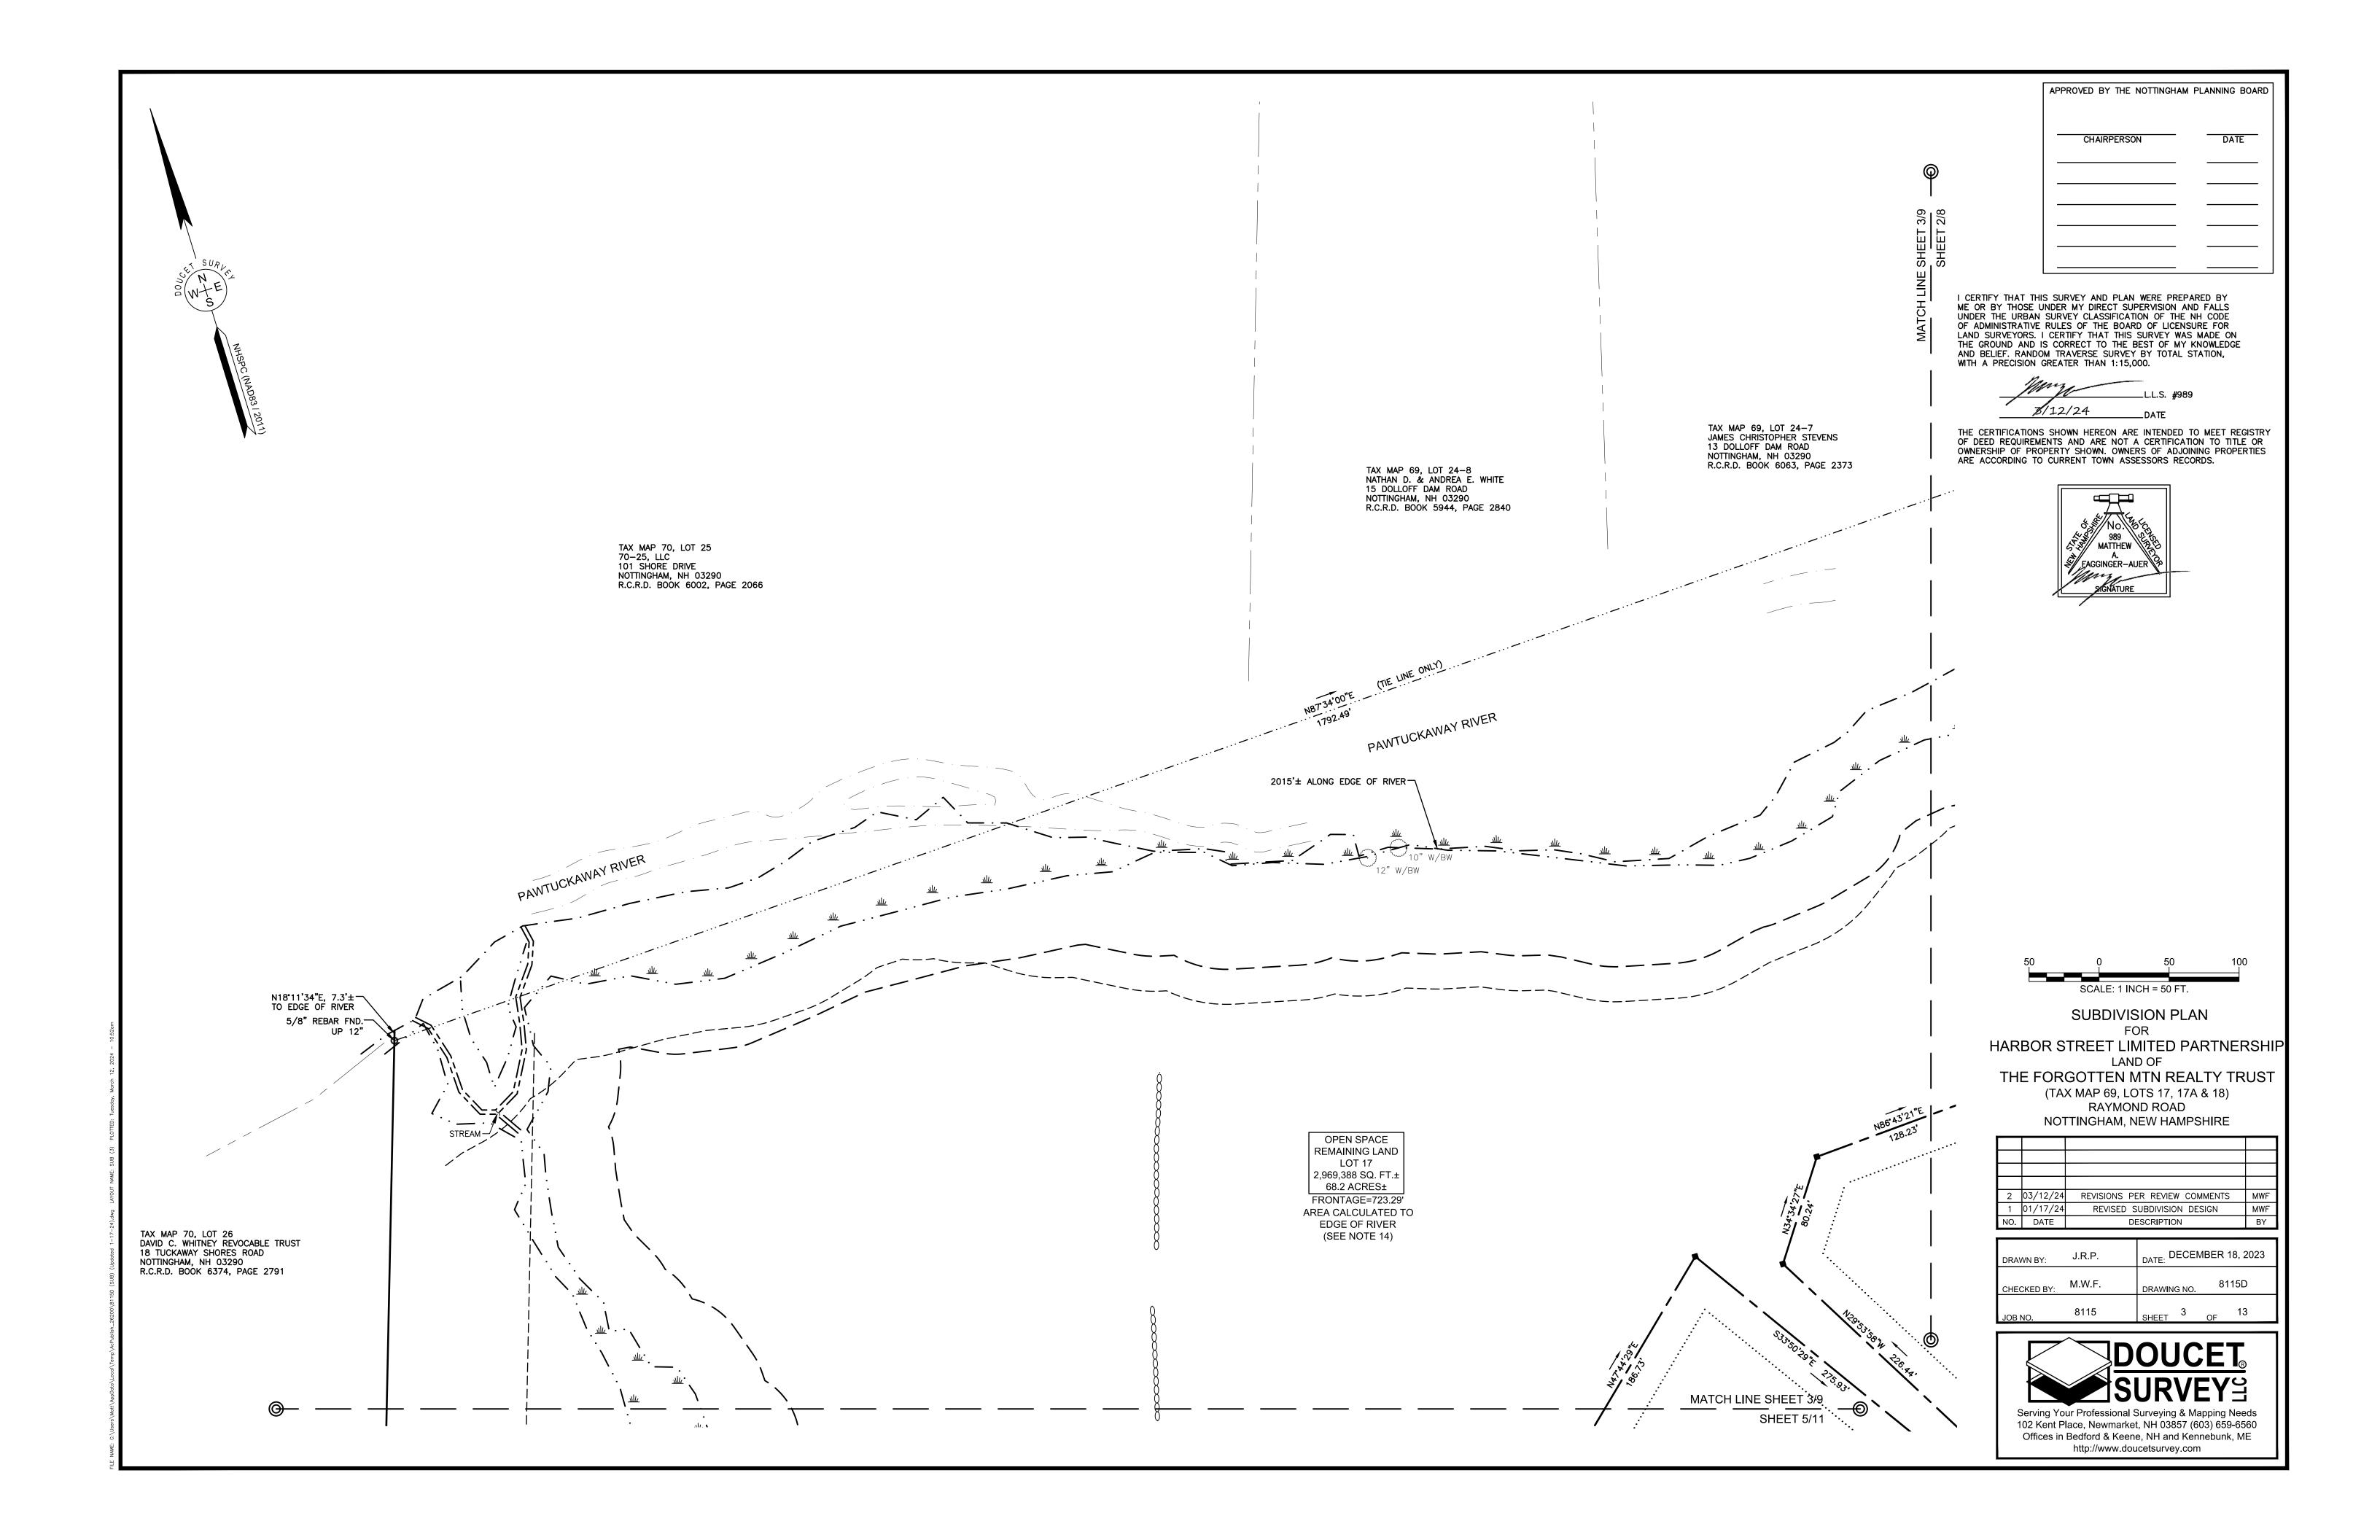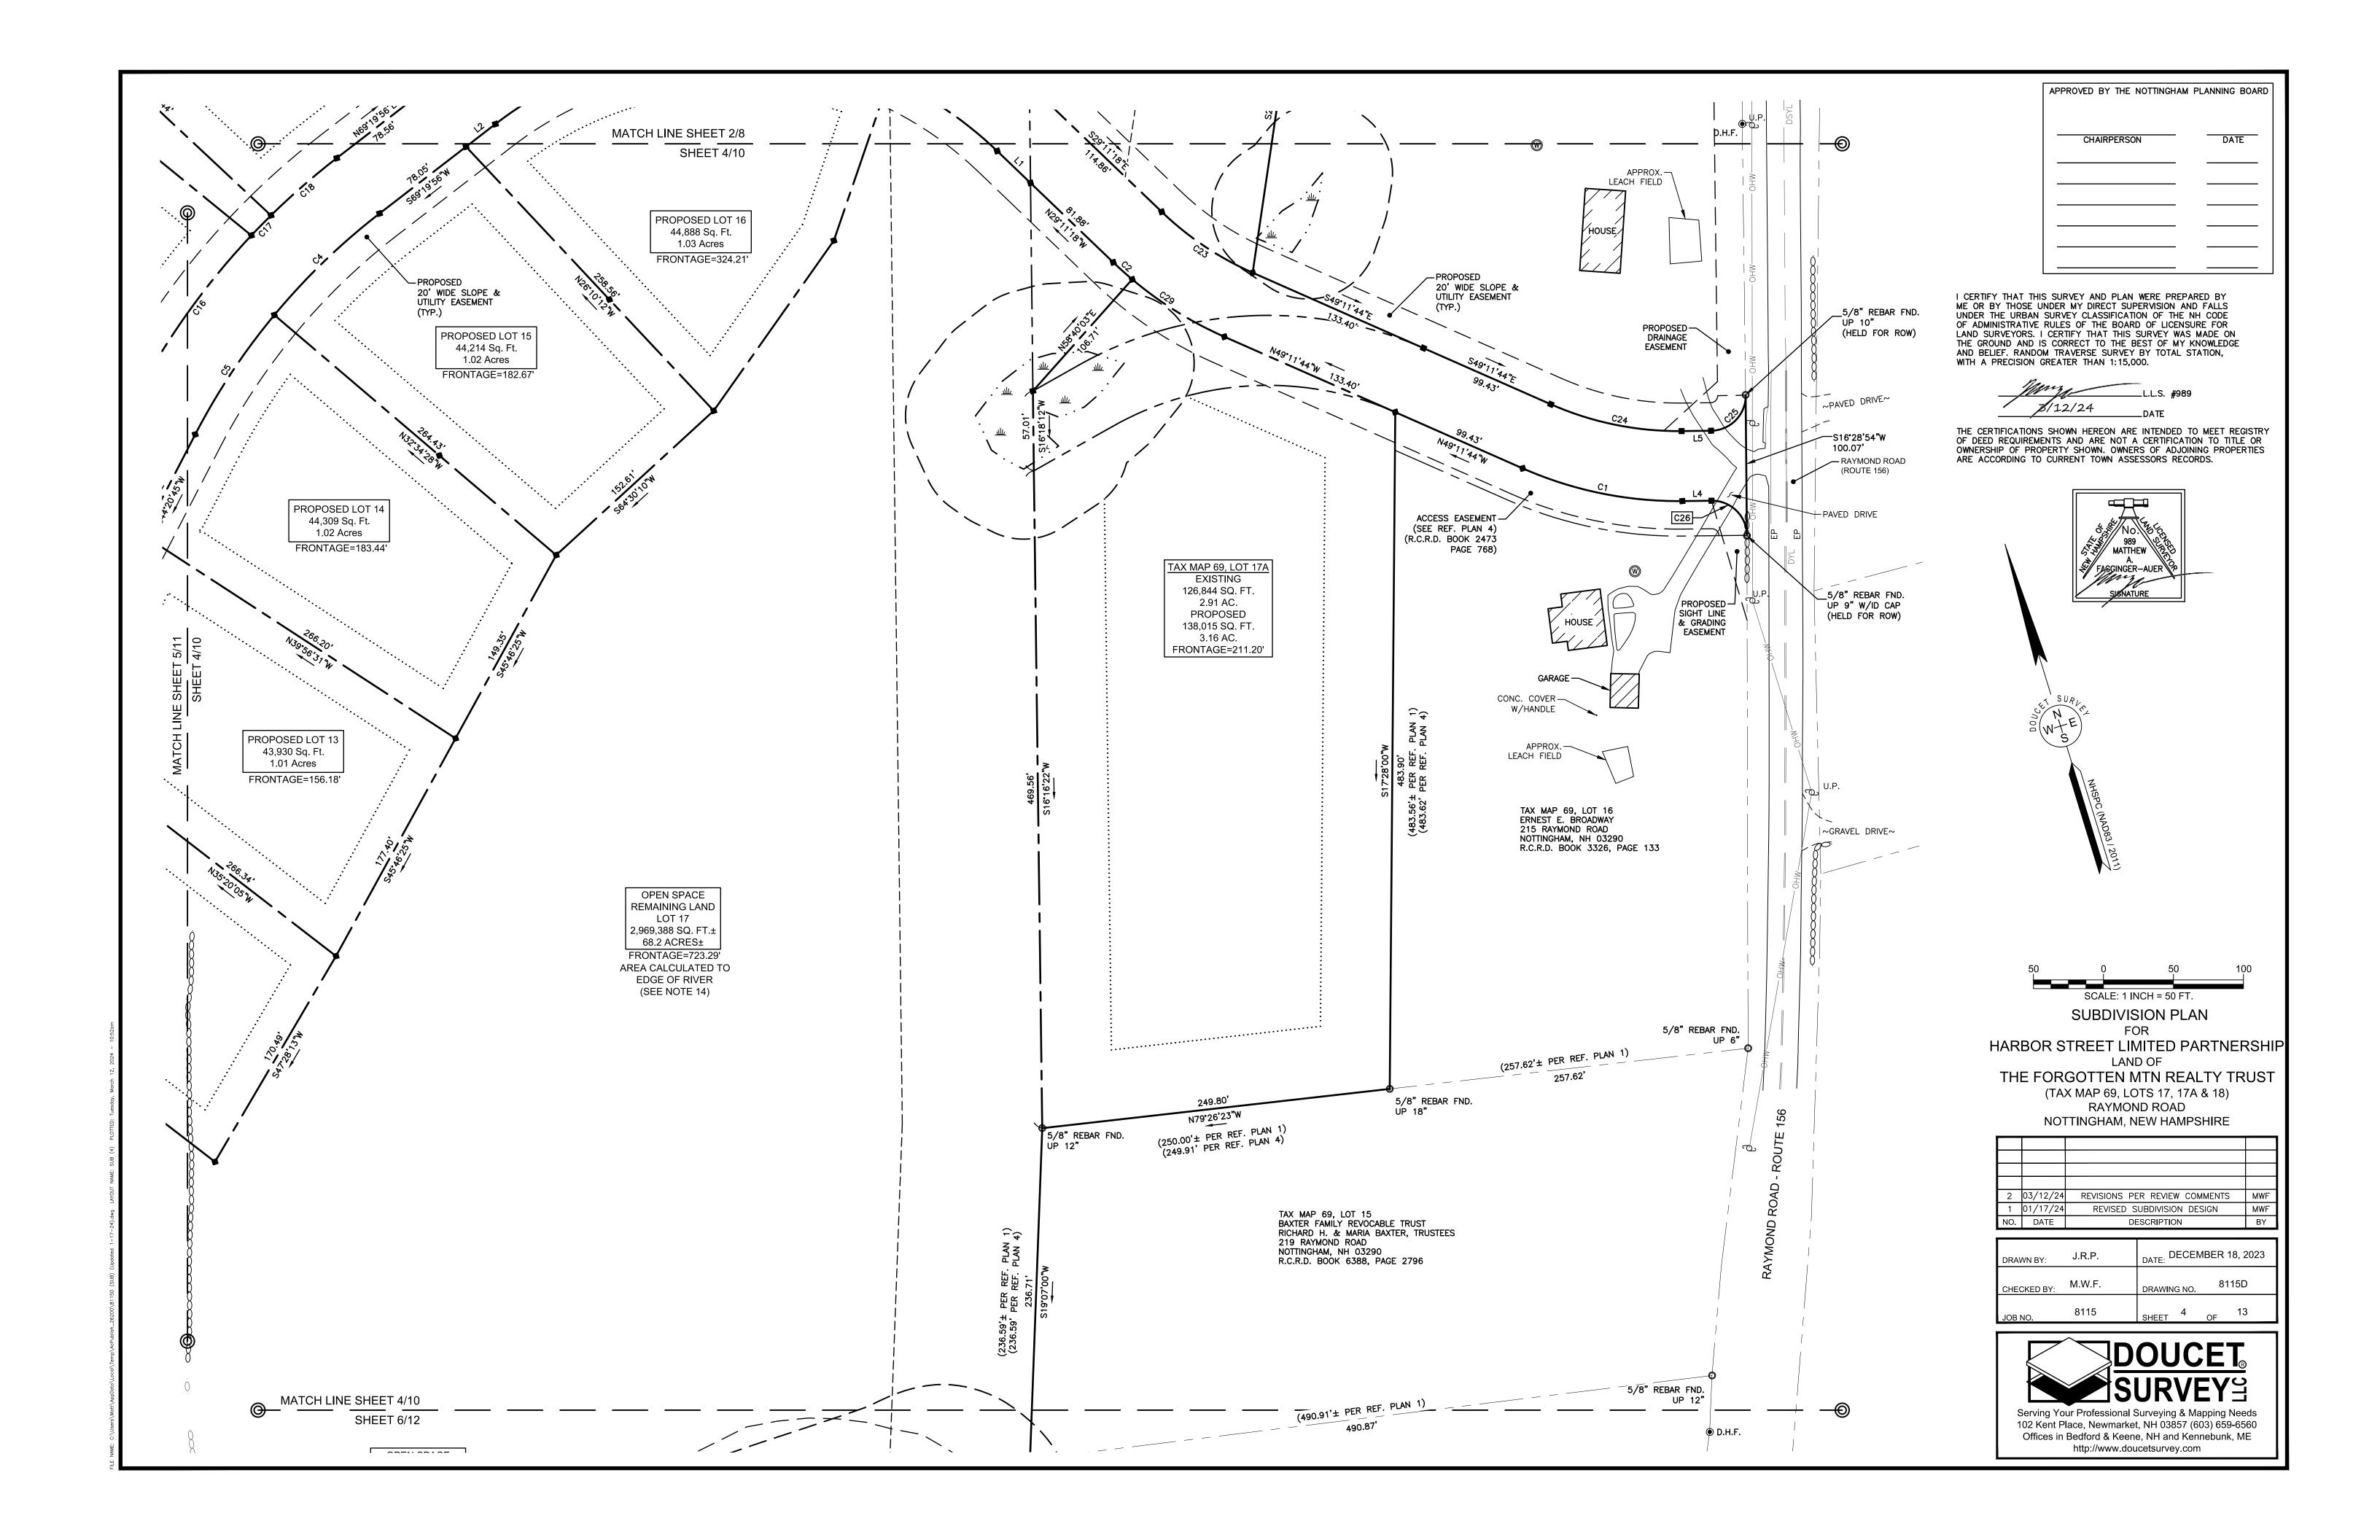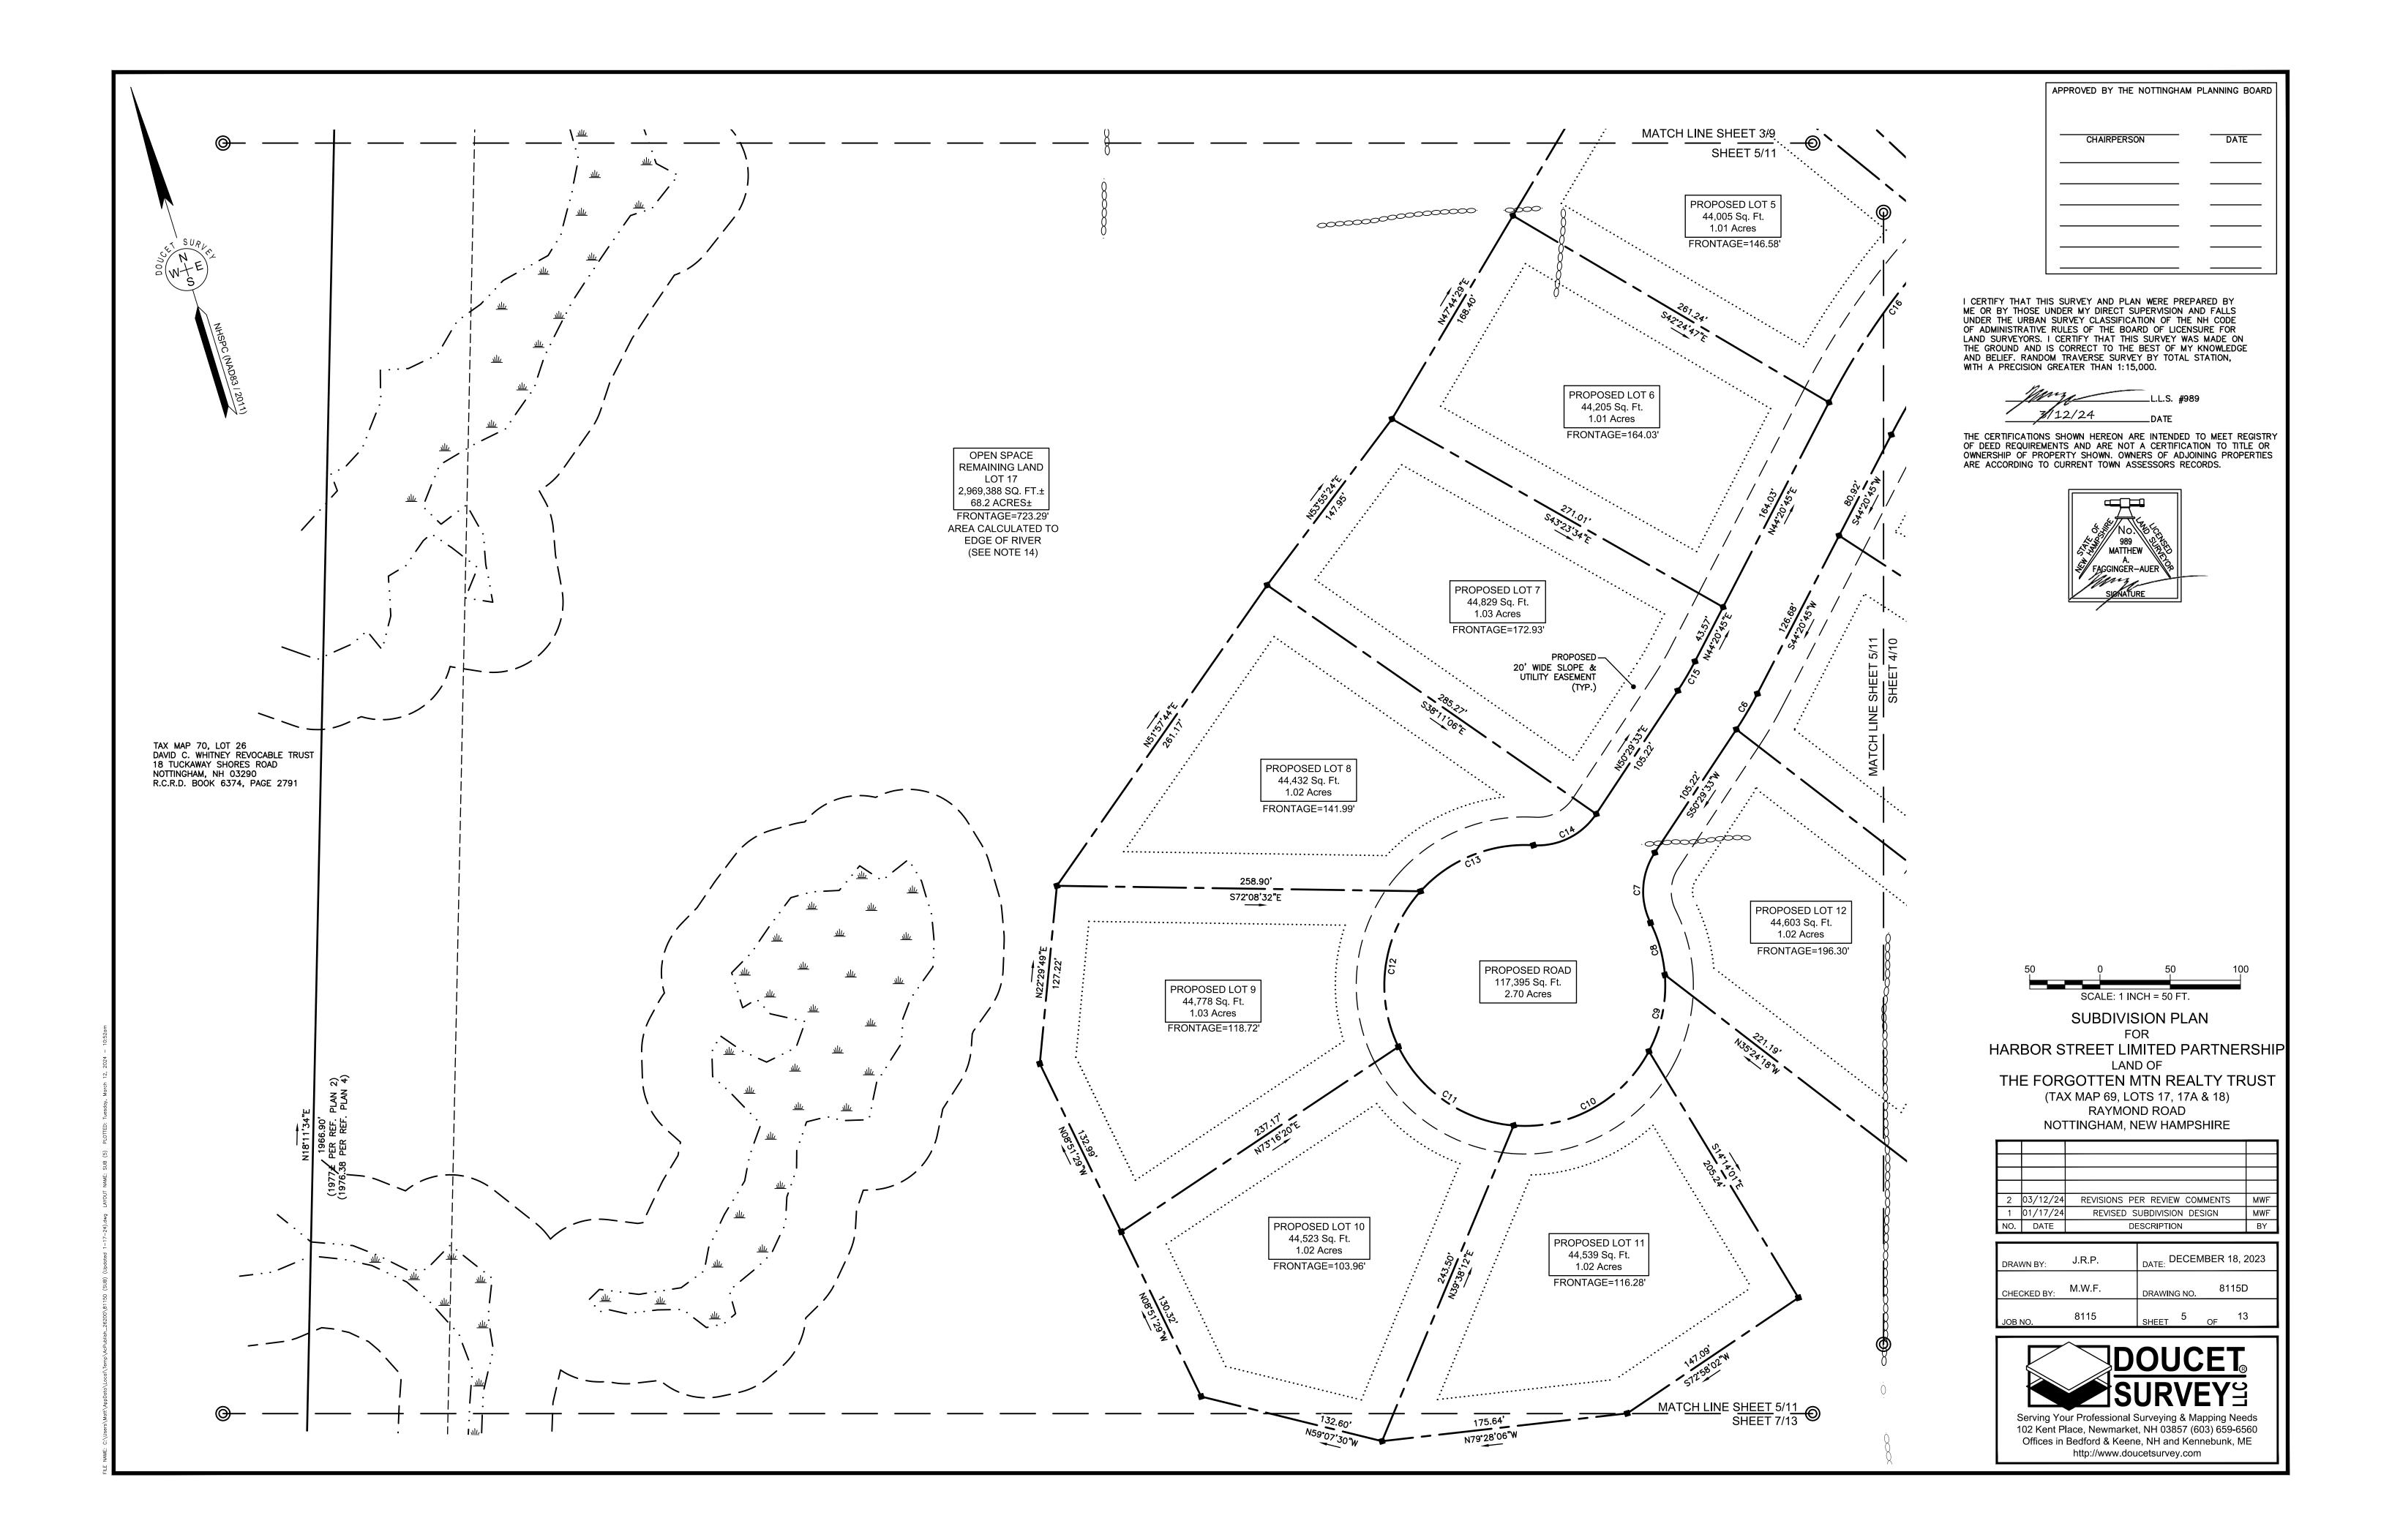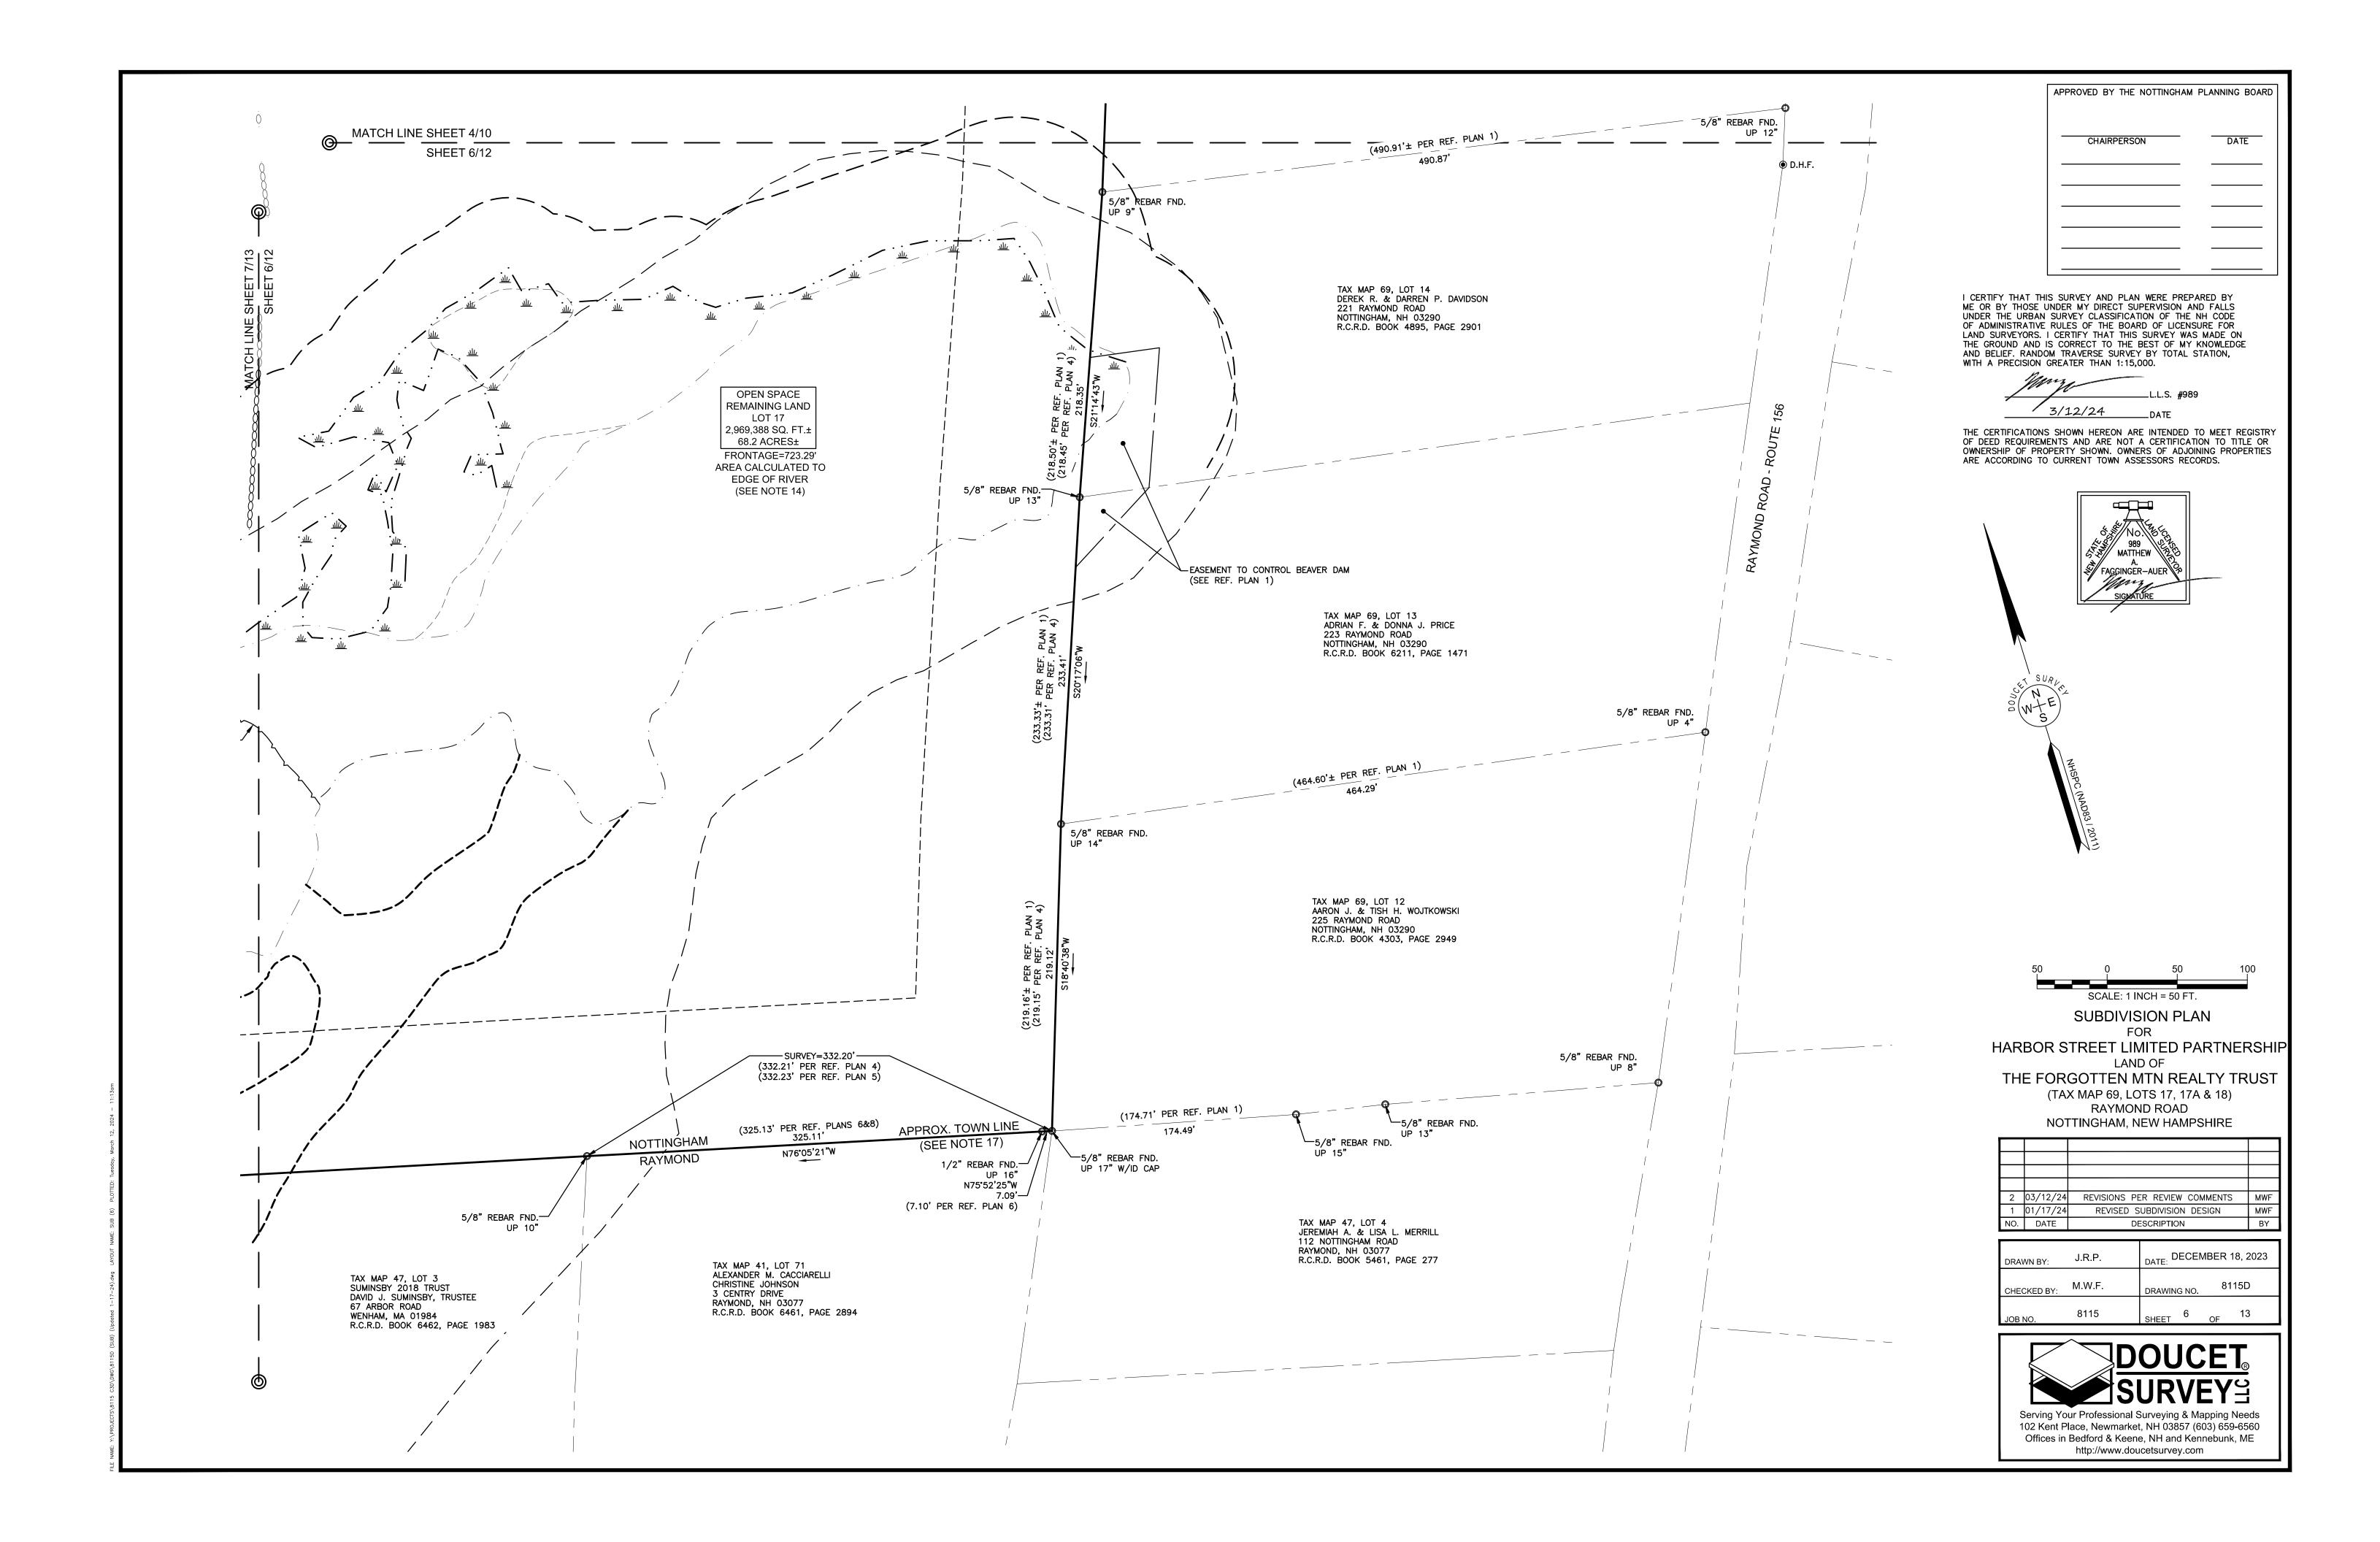
THE CERTIFICATIONS SHOWN HEREON ARE INTENDED TO MEET REGISTRY OF DEED REQUIREMENTS AND ARE NOT A CERTIFICATION TO TITLE OR OWNERSHIP OF PROPERTY SHOWN. OWNERS OF ADJOINING PROPERTIES ARE ACCORDING TO CURRENT TOWN ASSESSORS RECORDS.

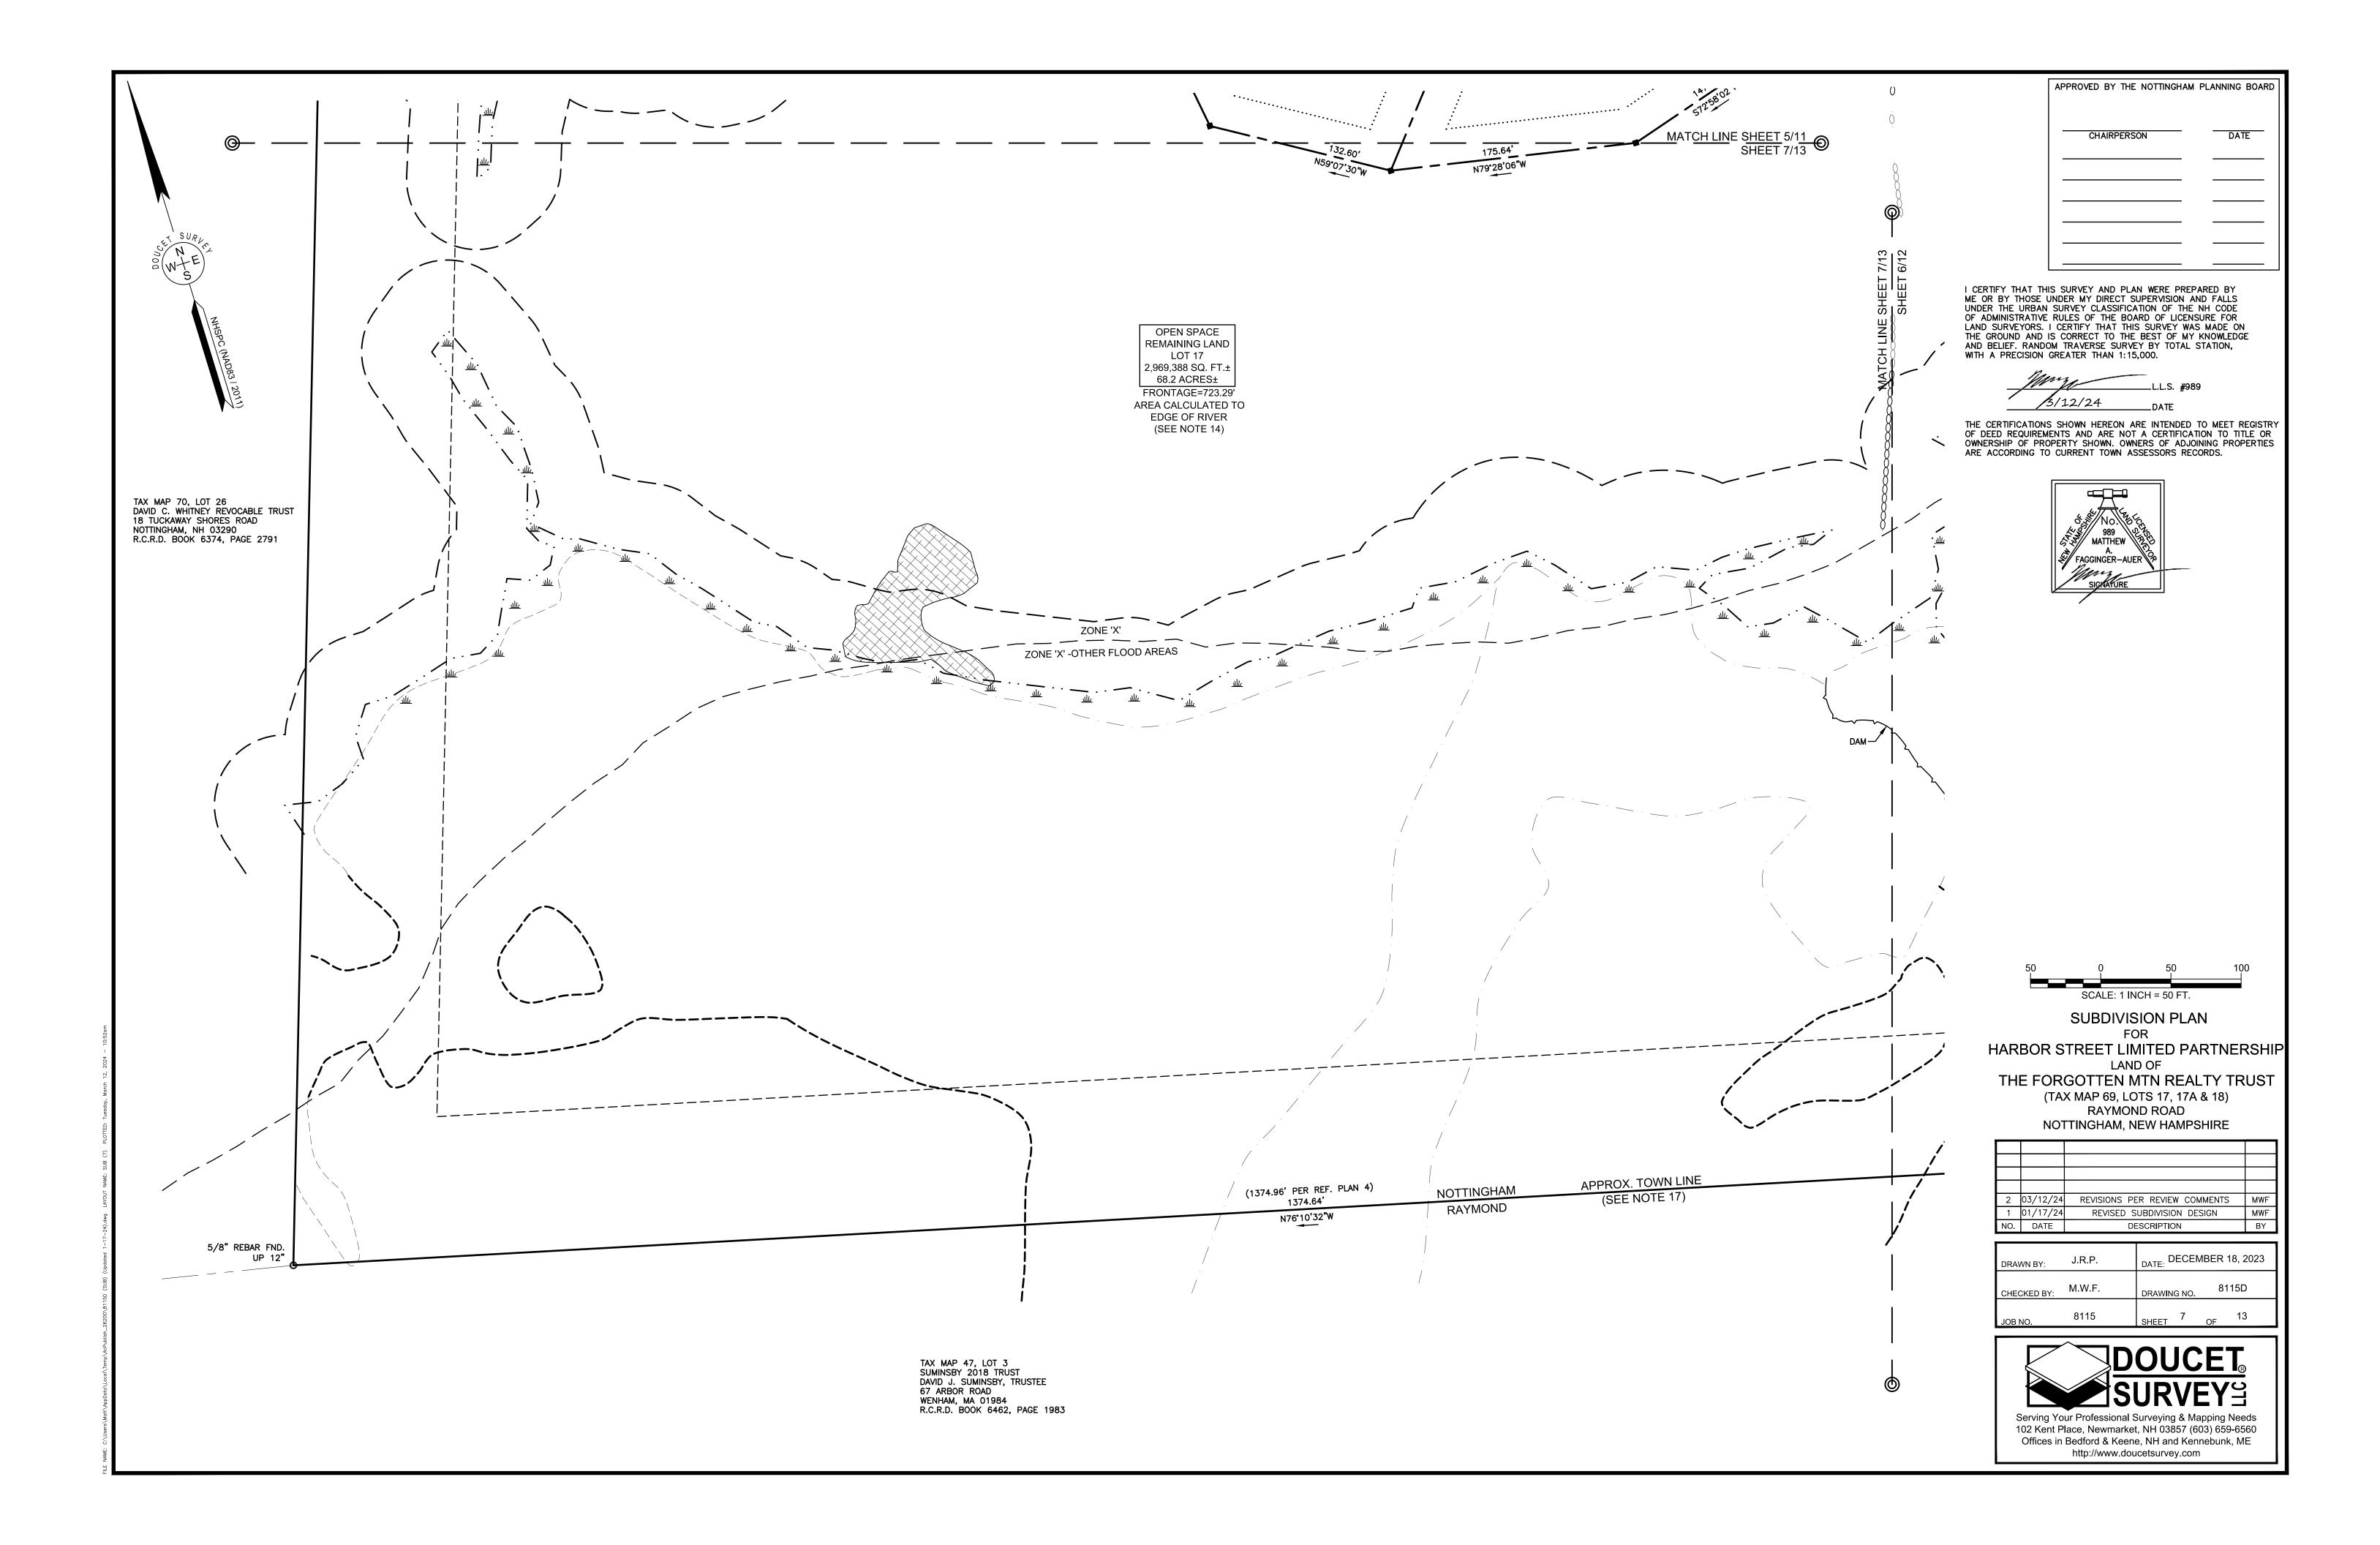


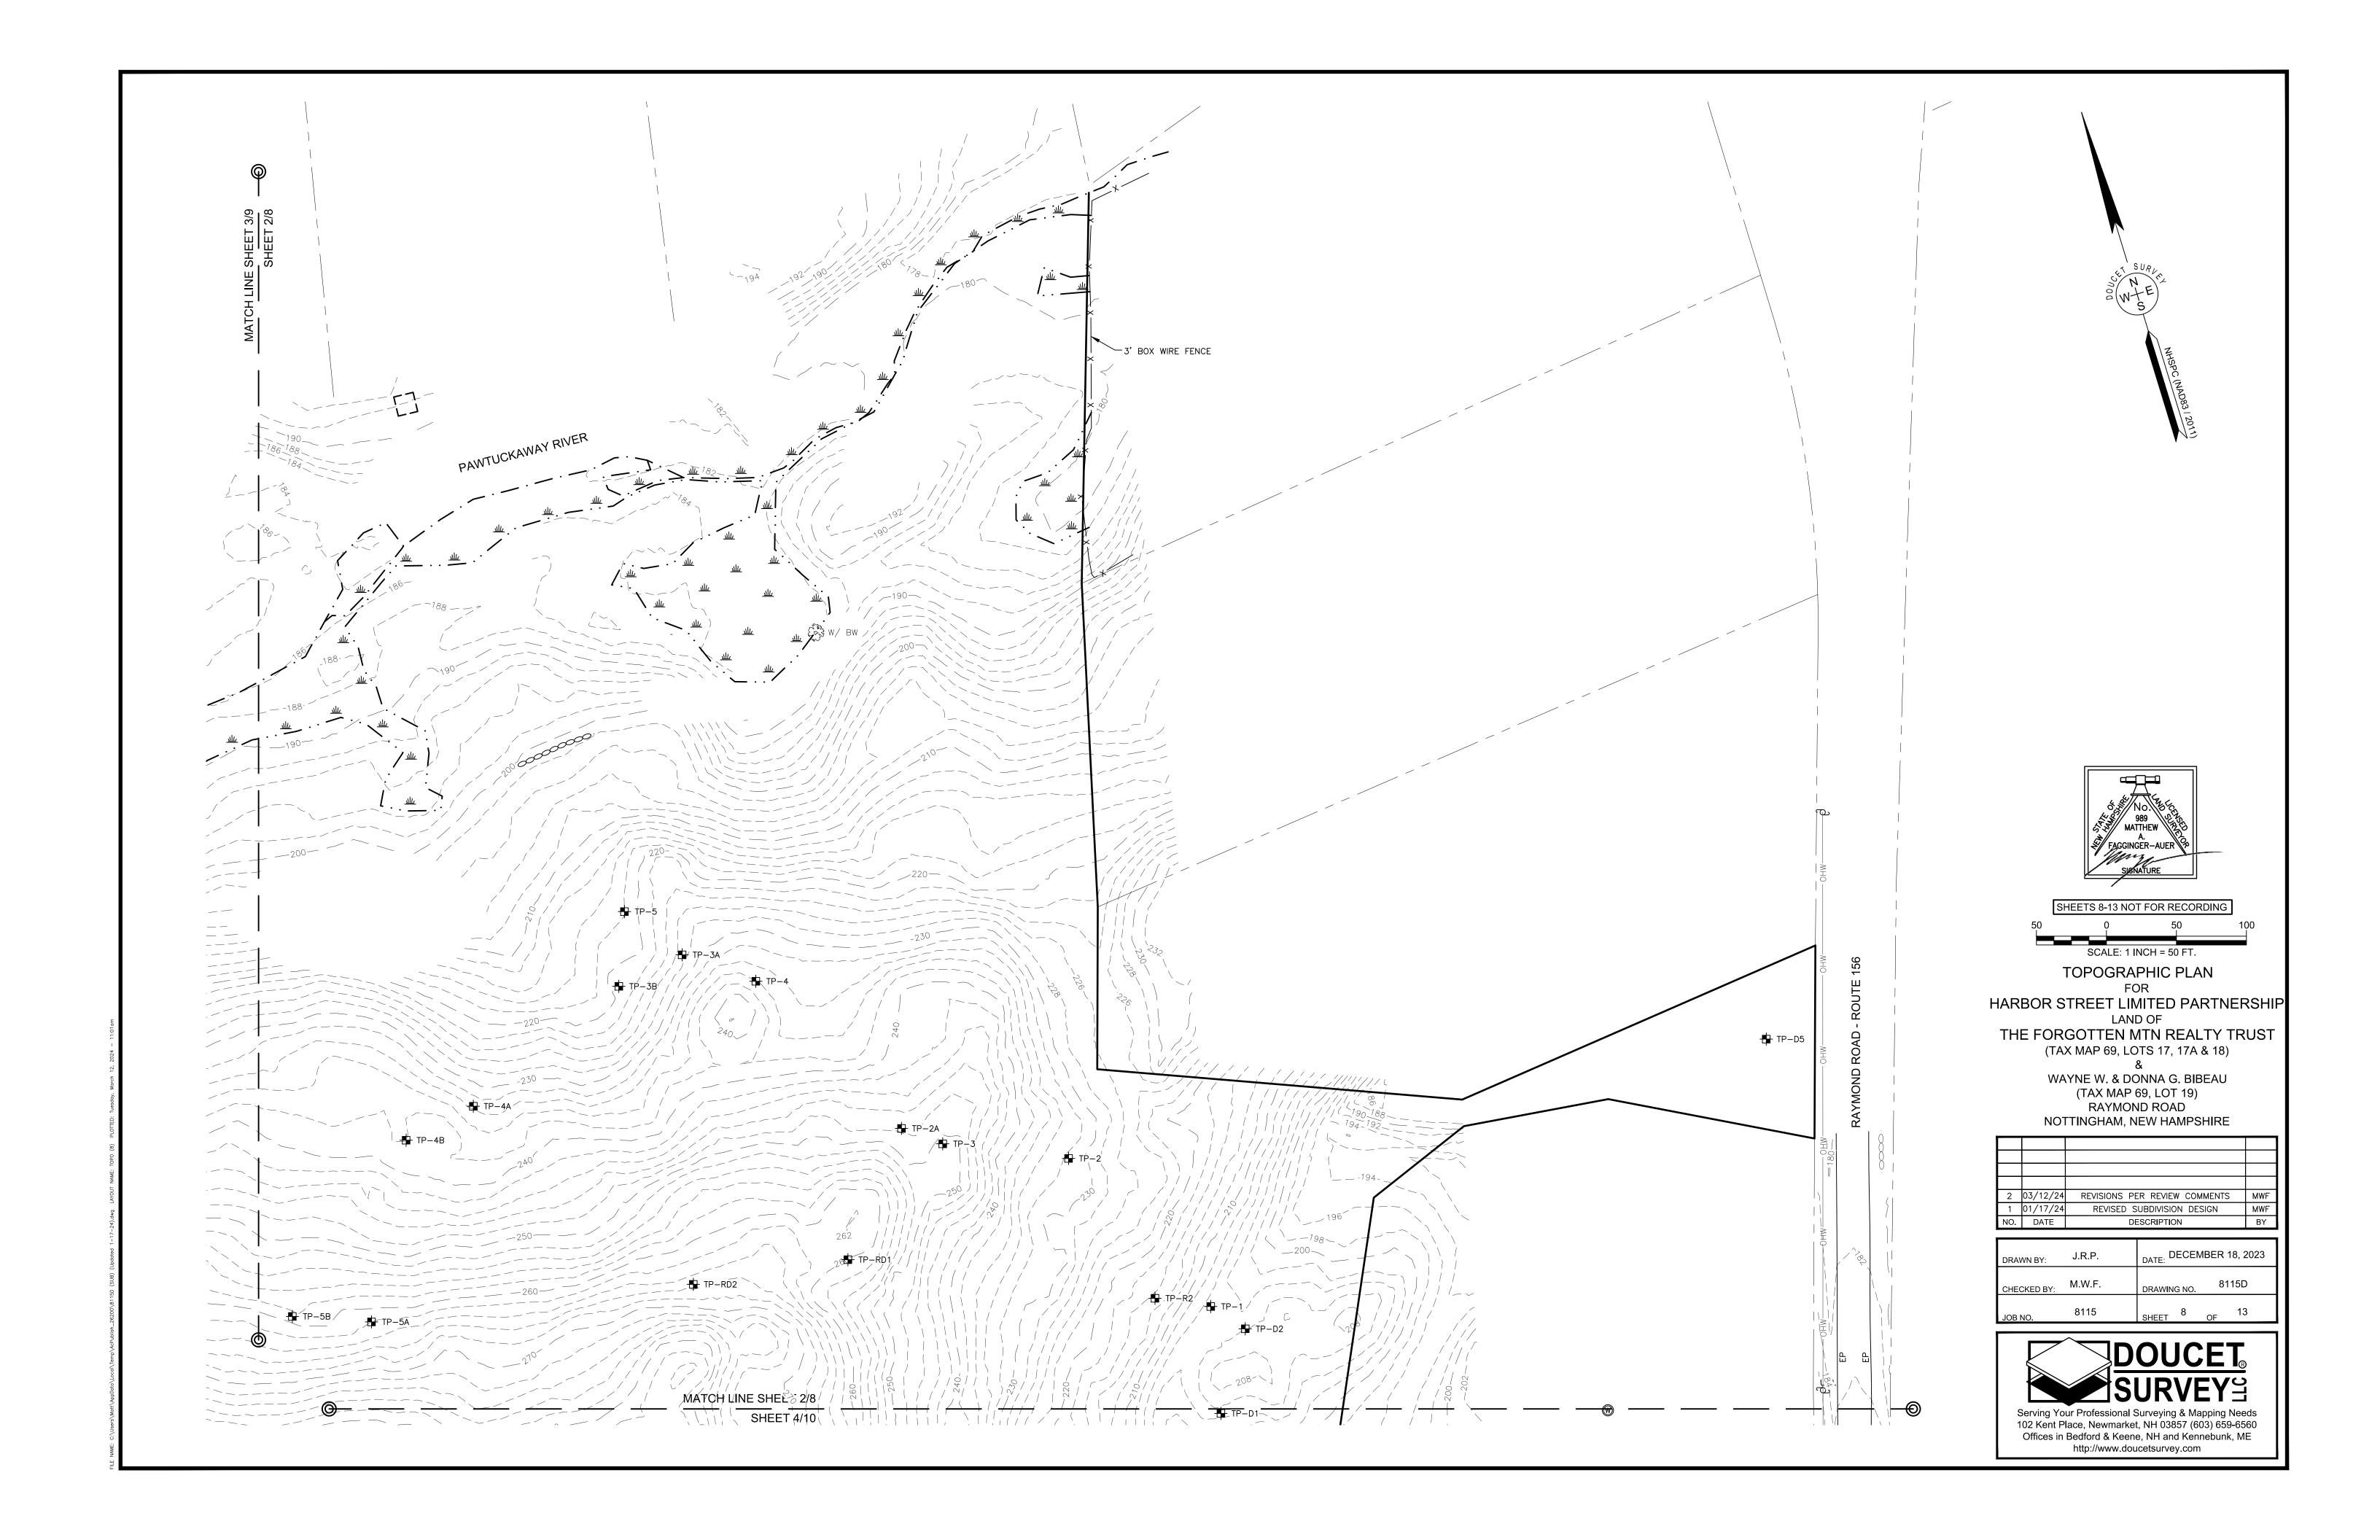


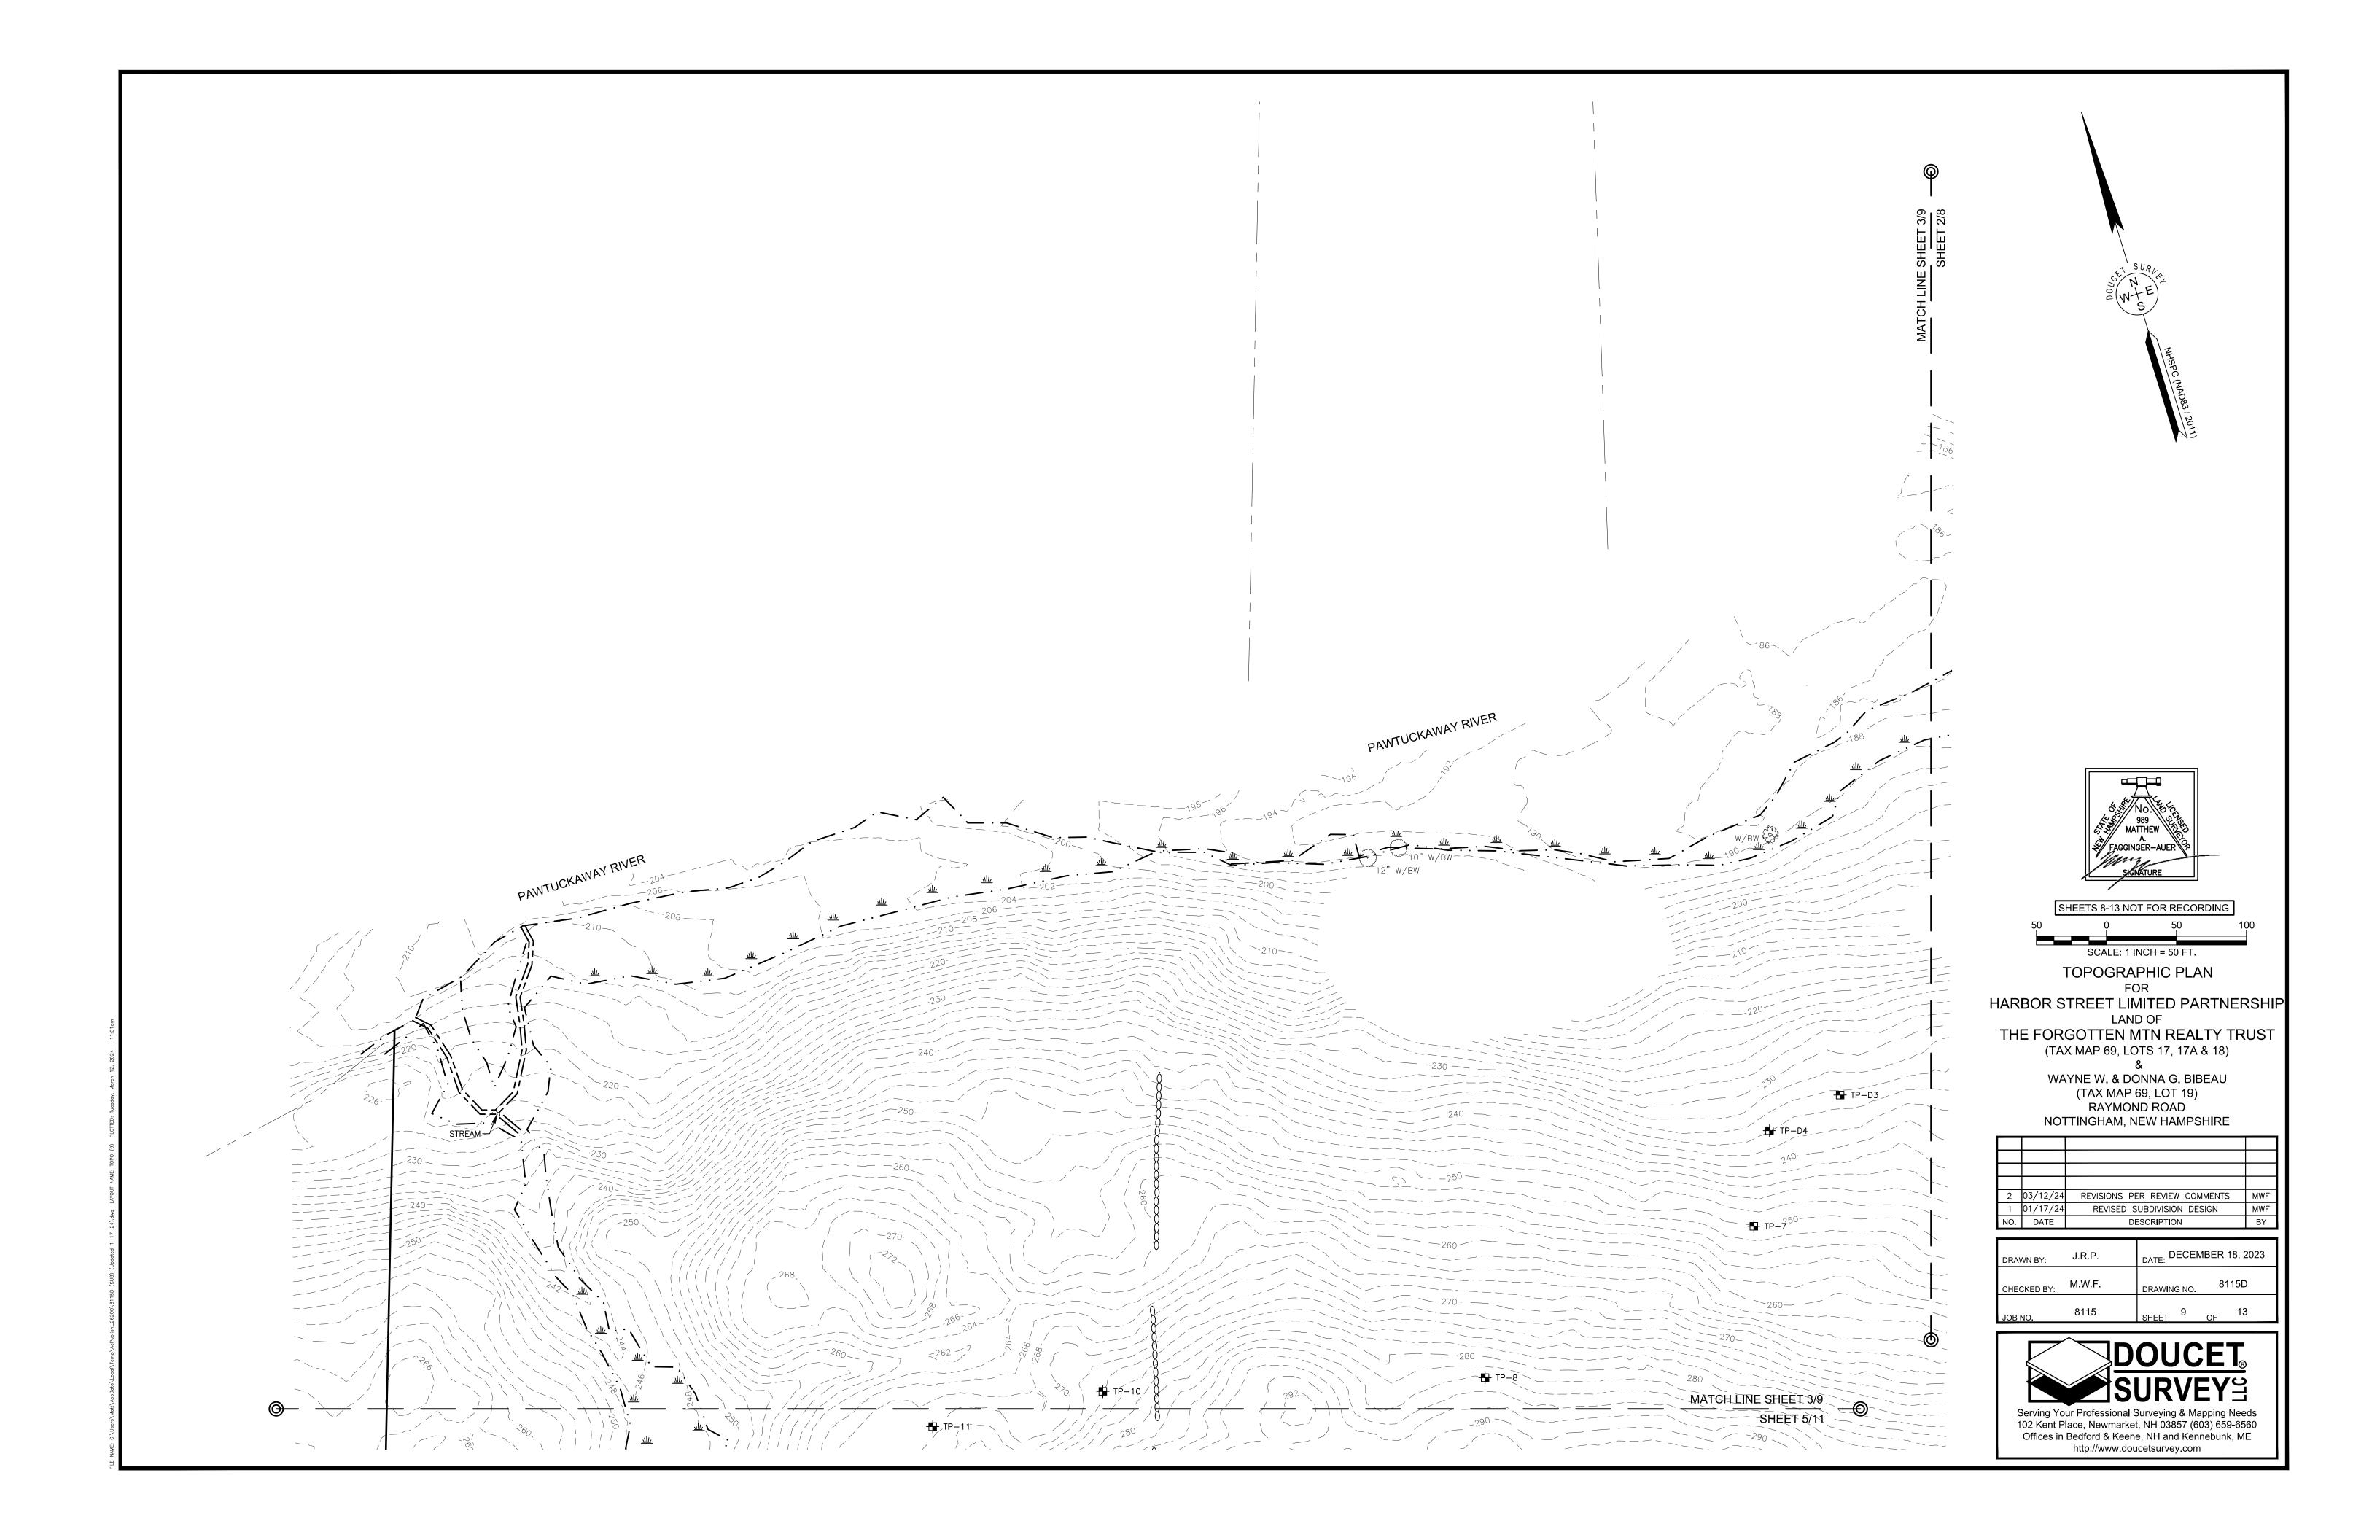


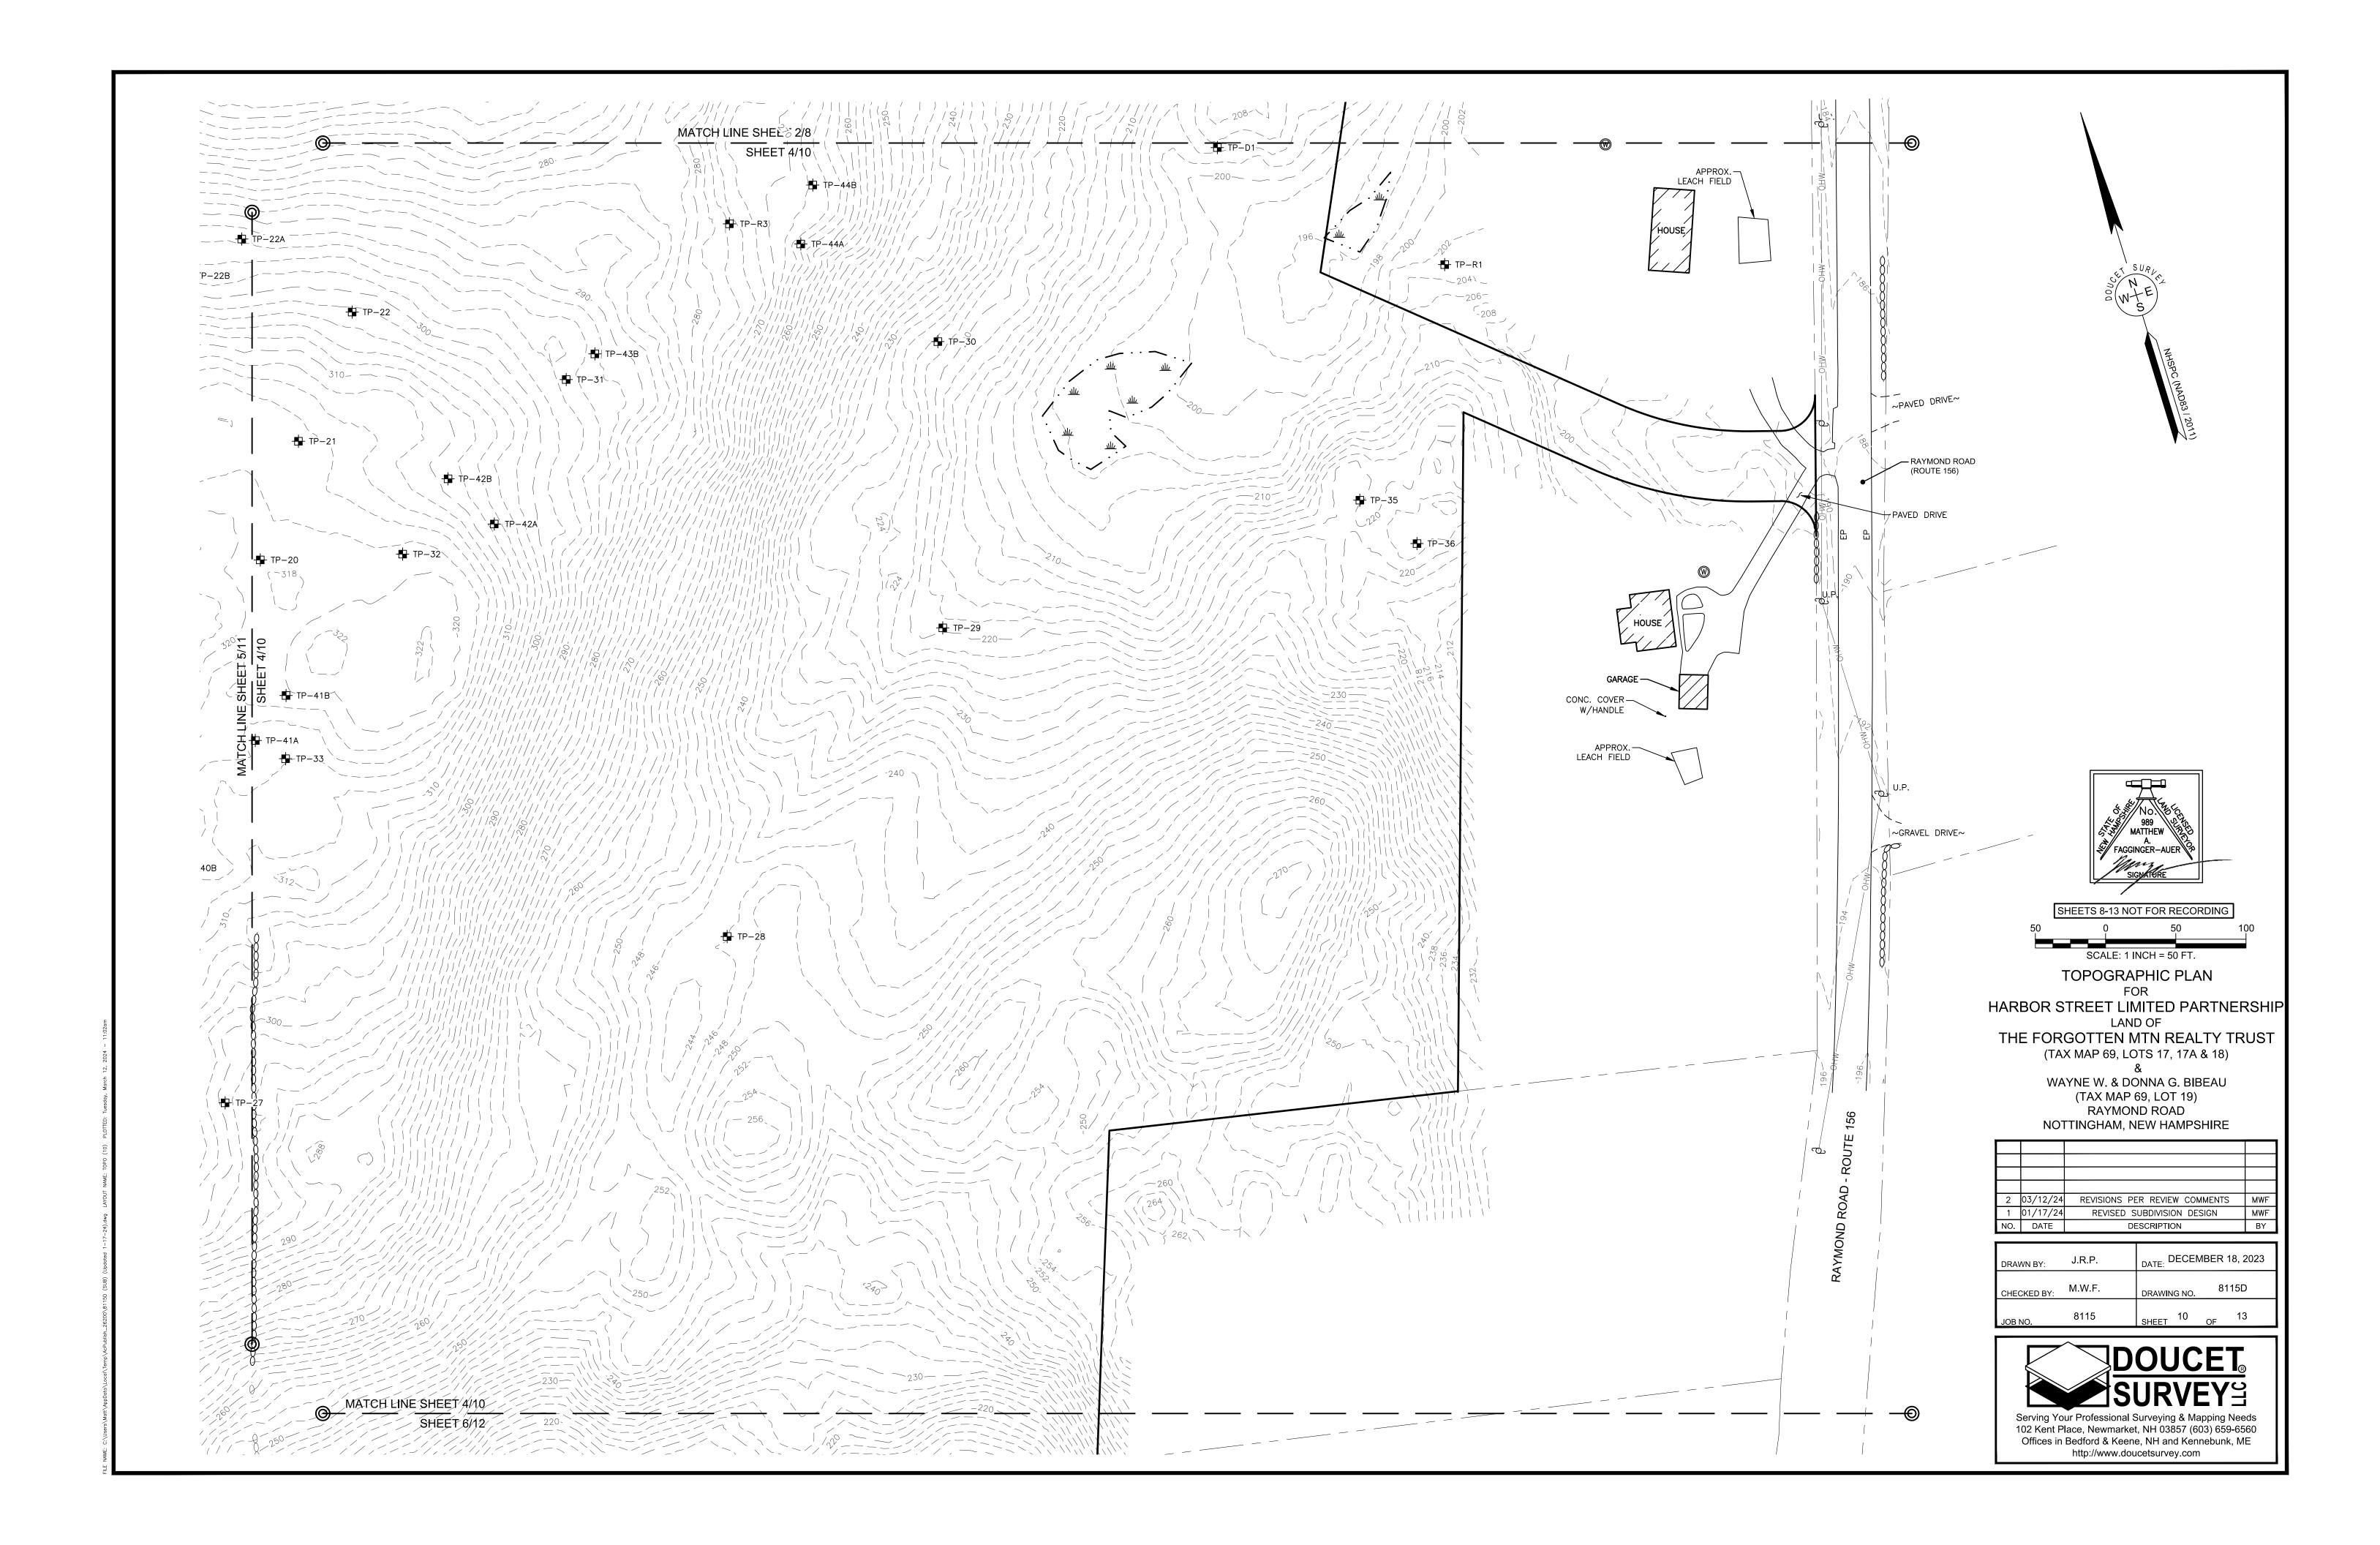


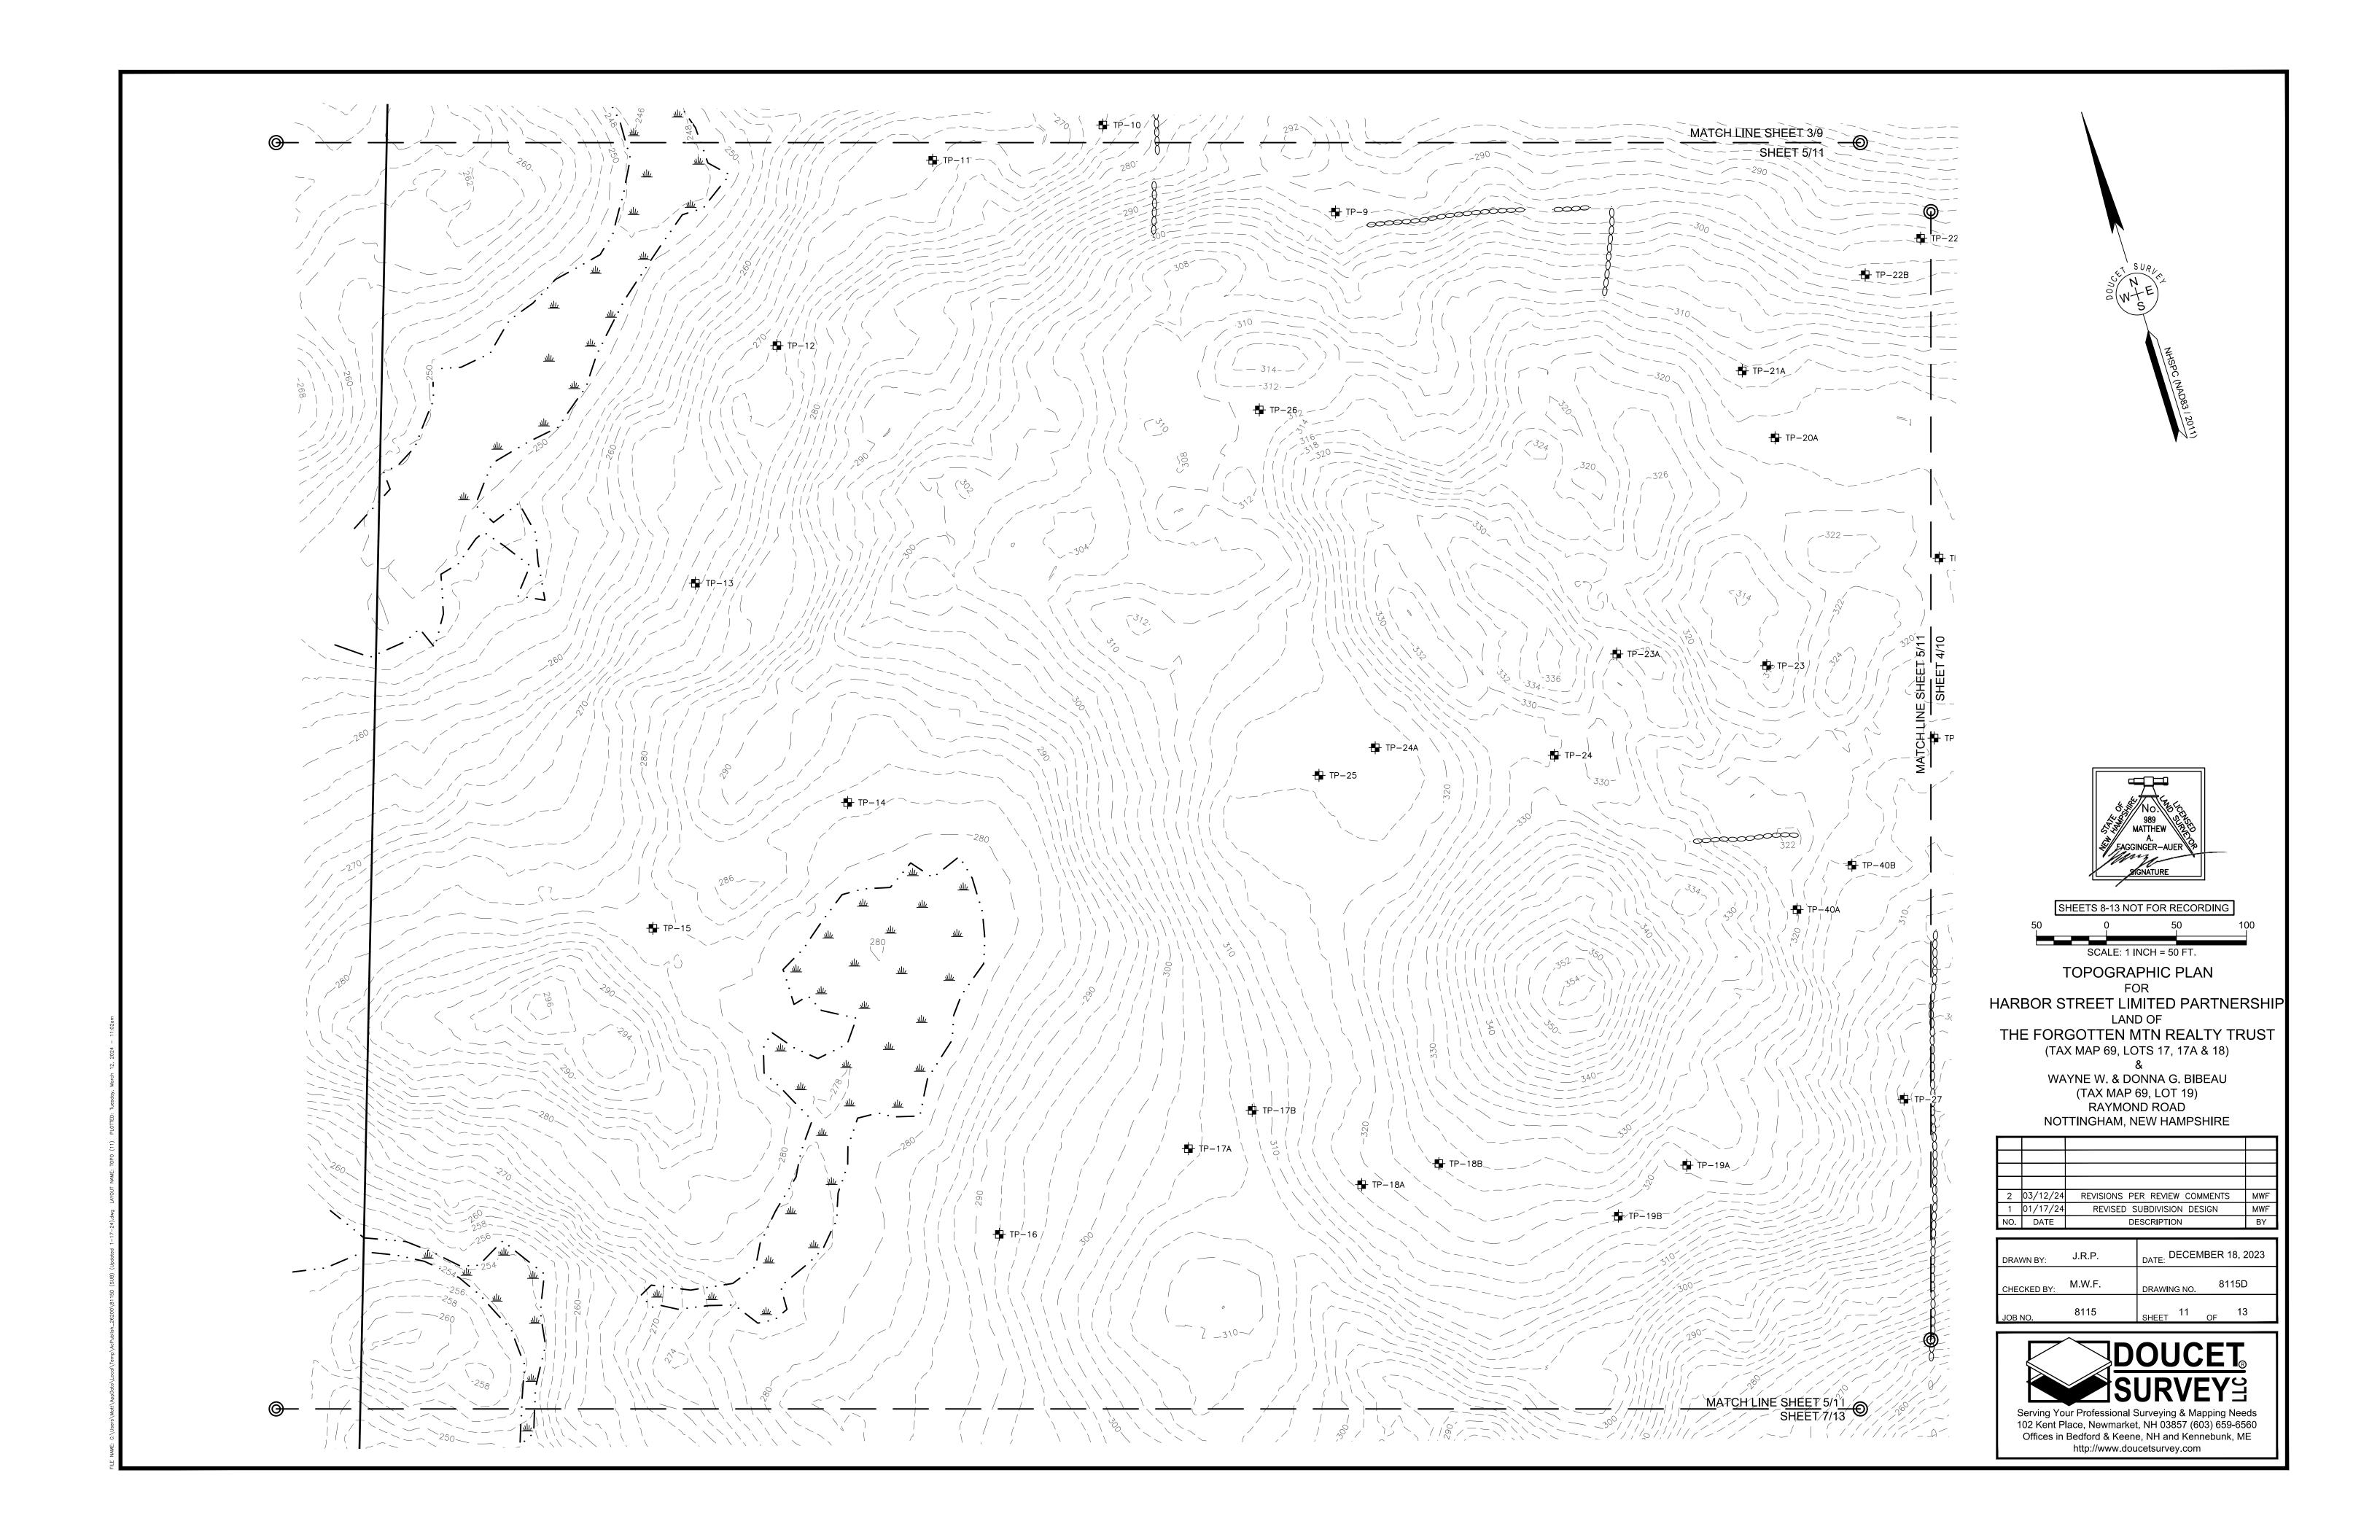


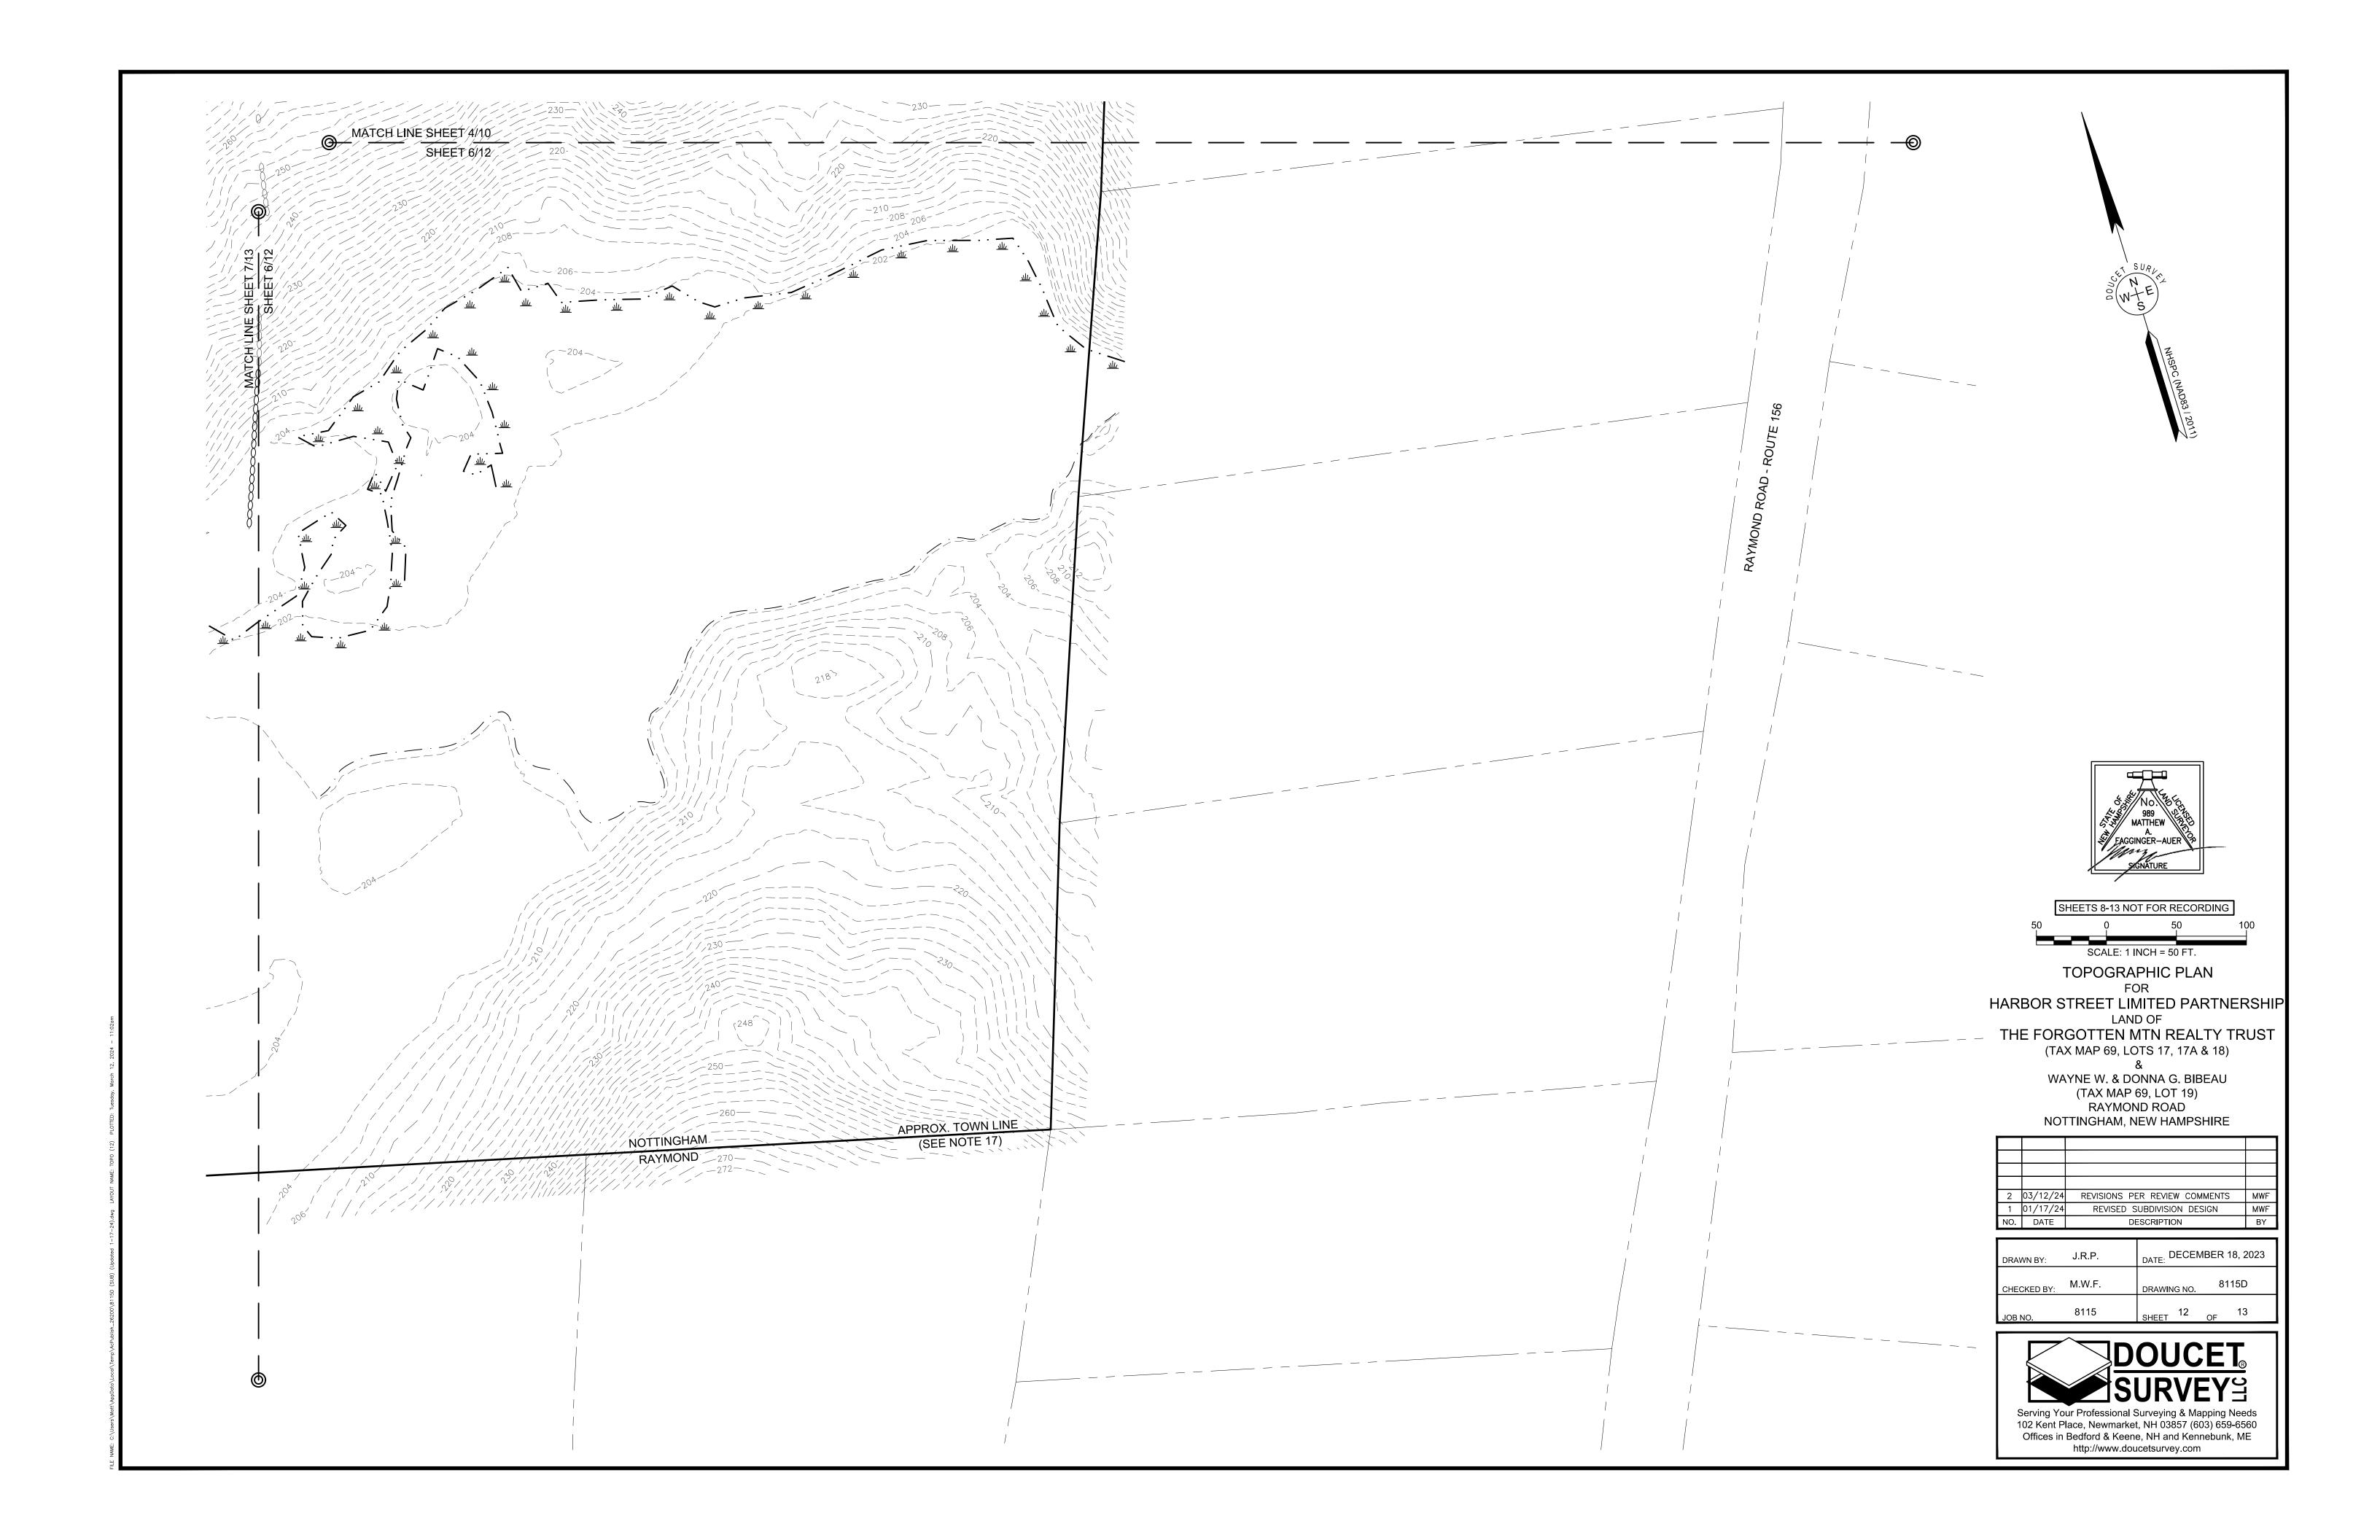


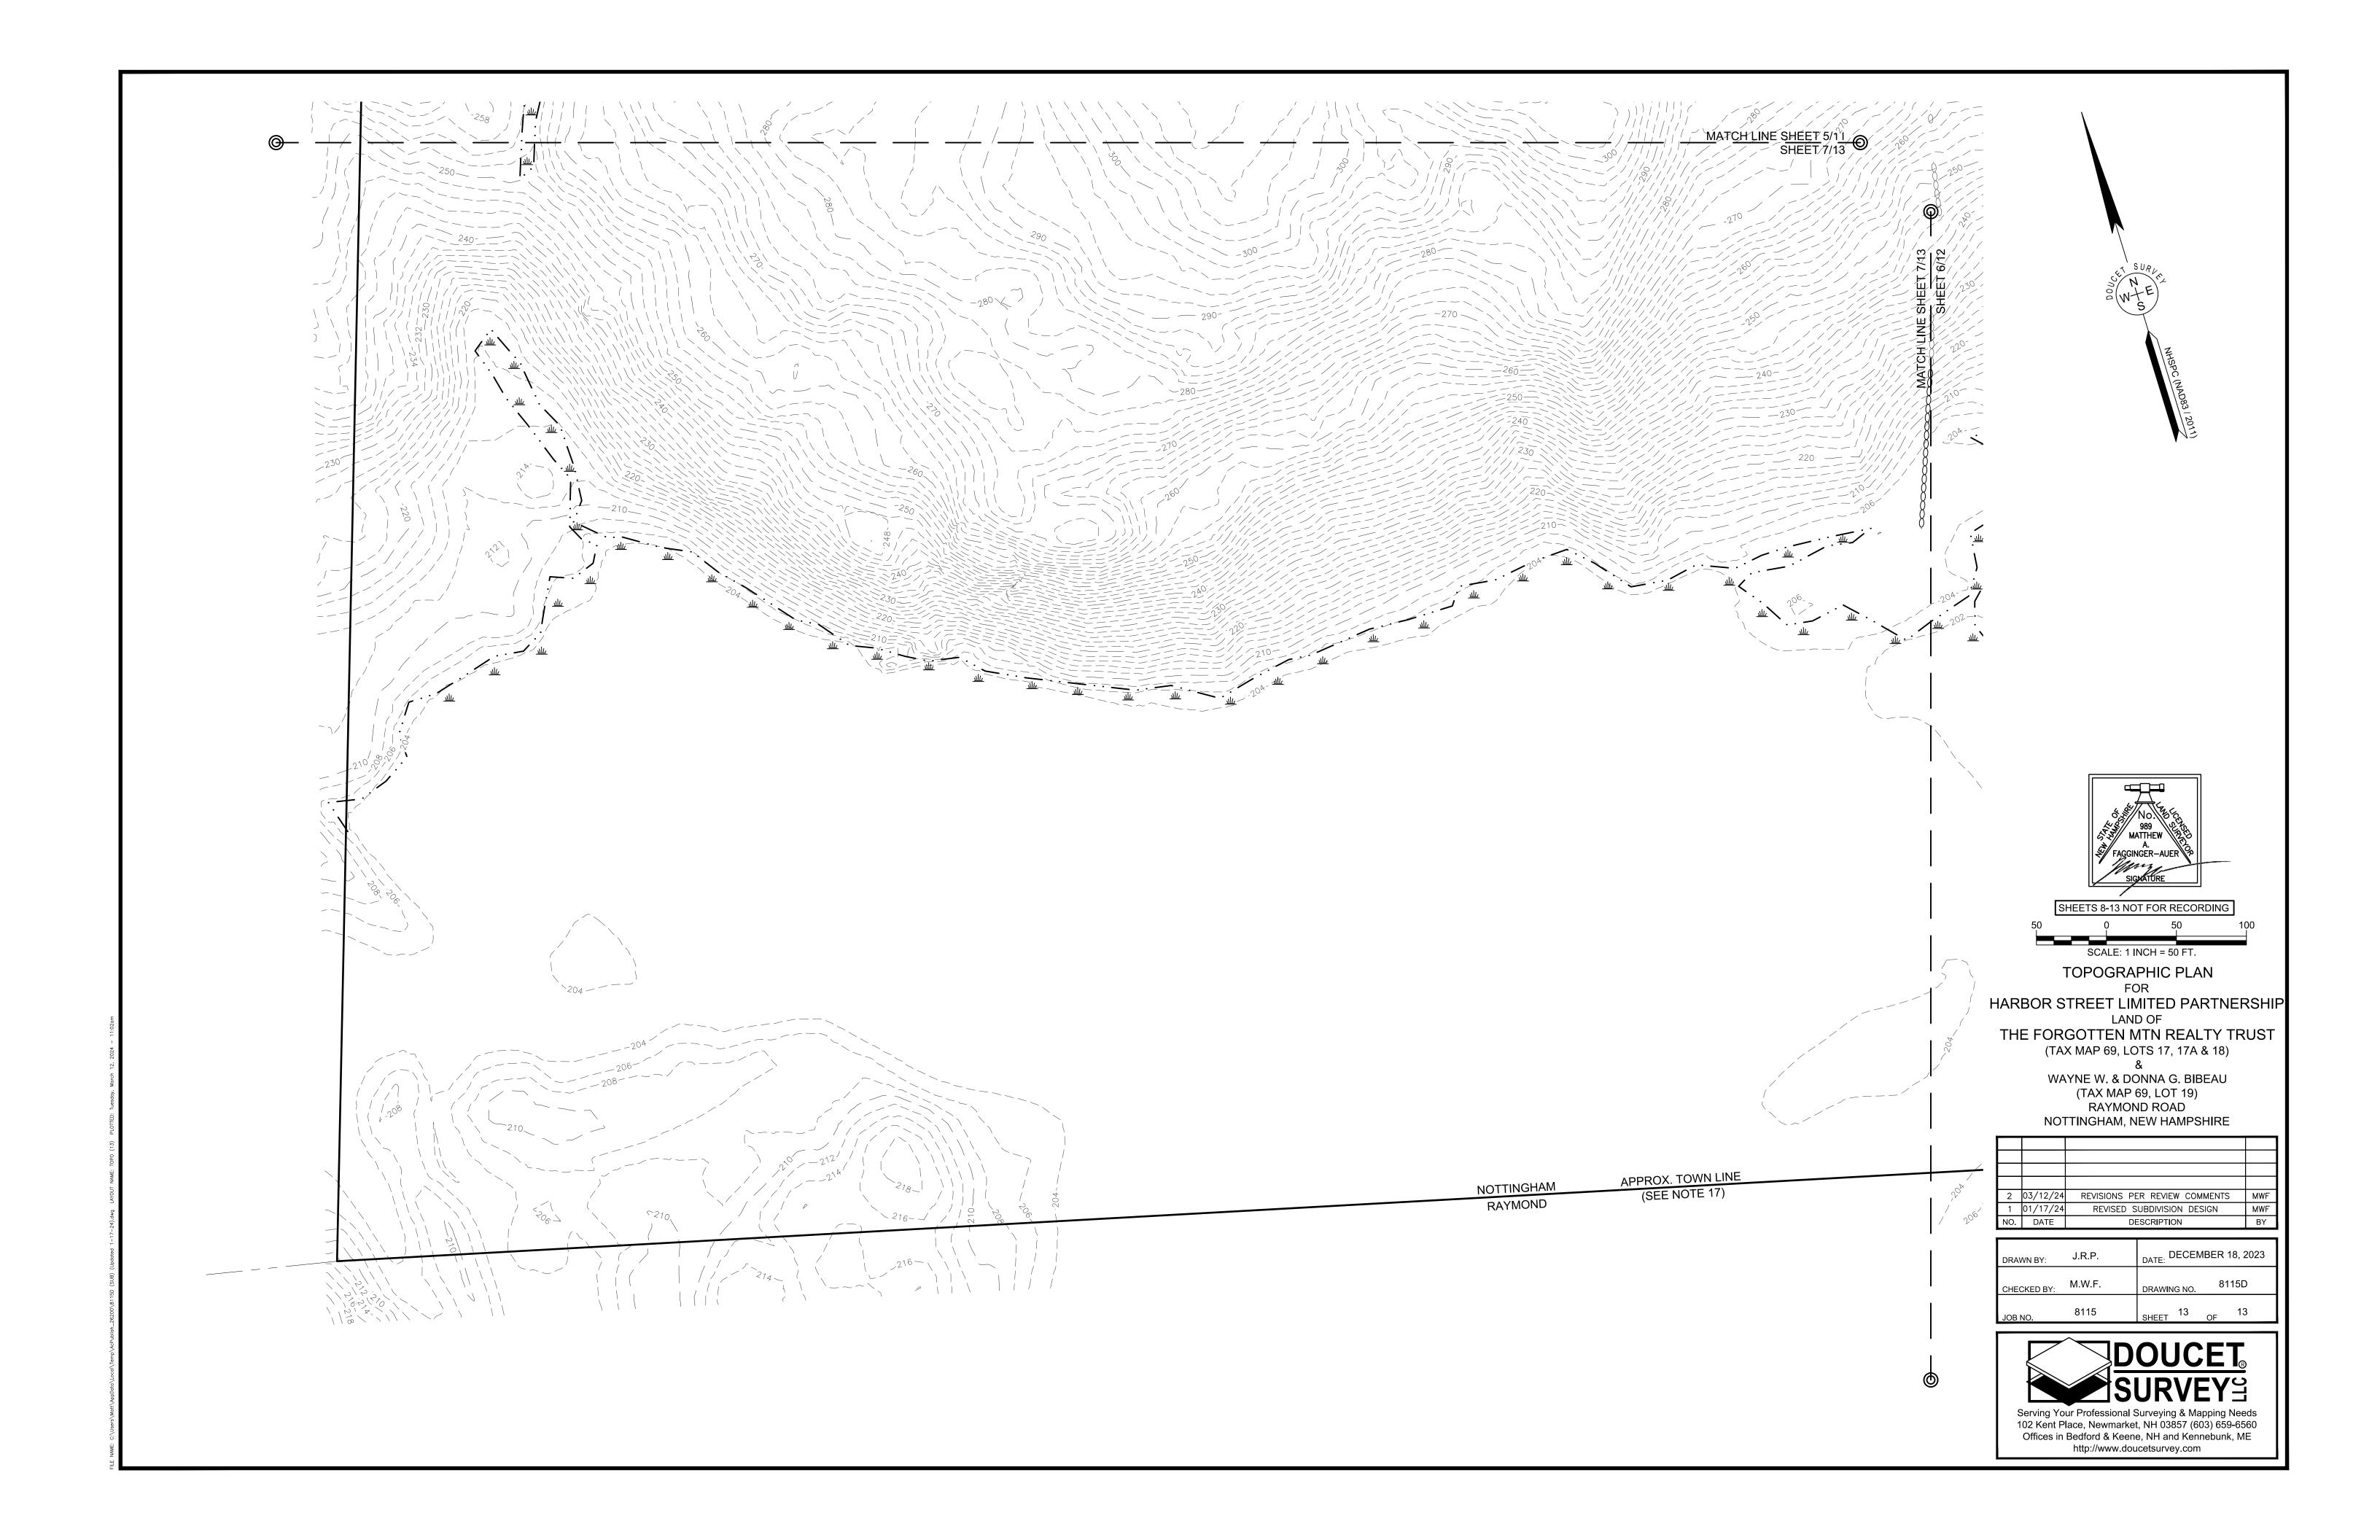


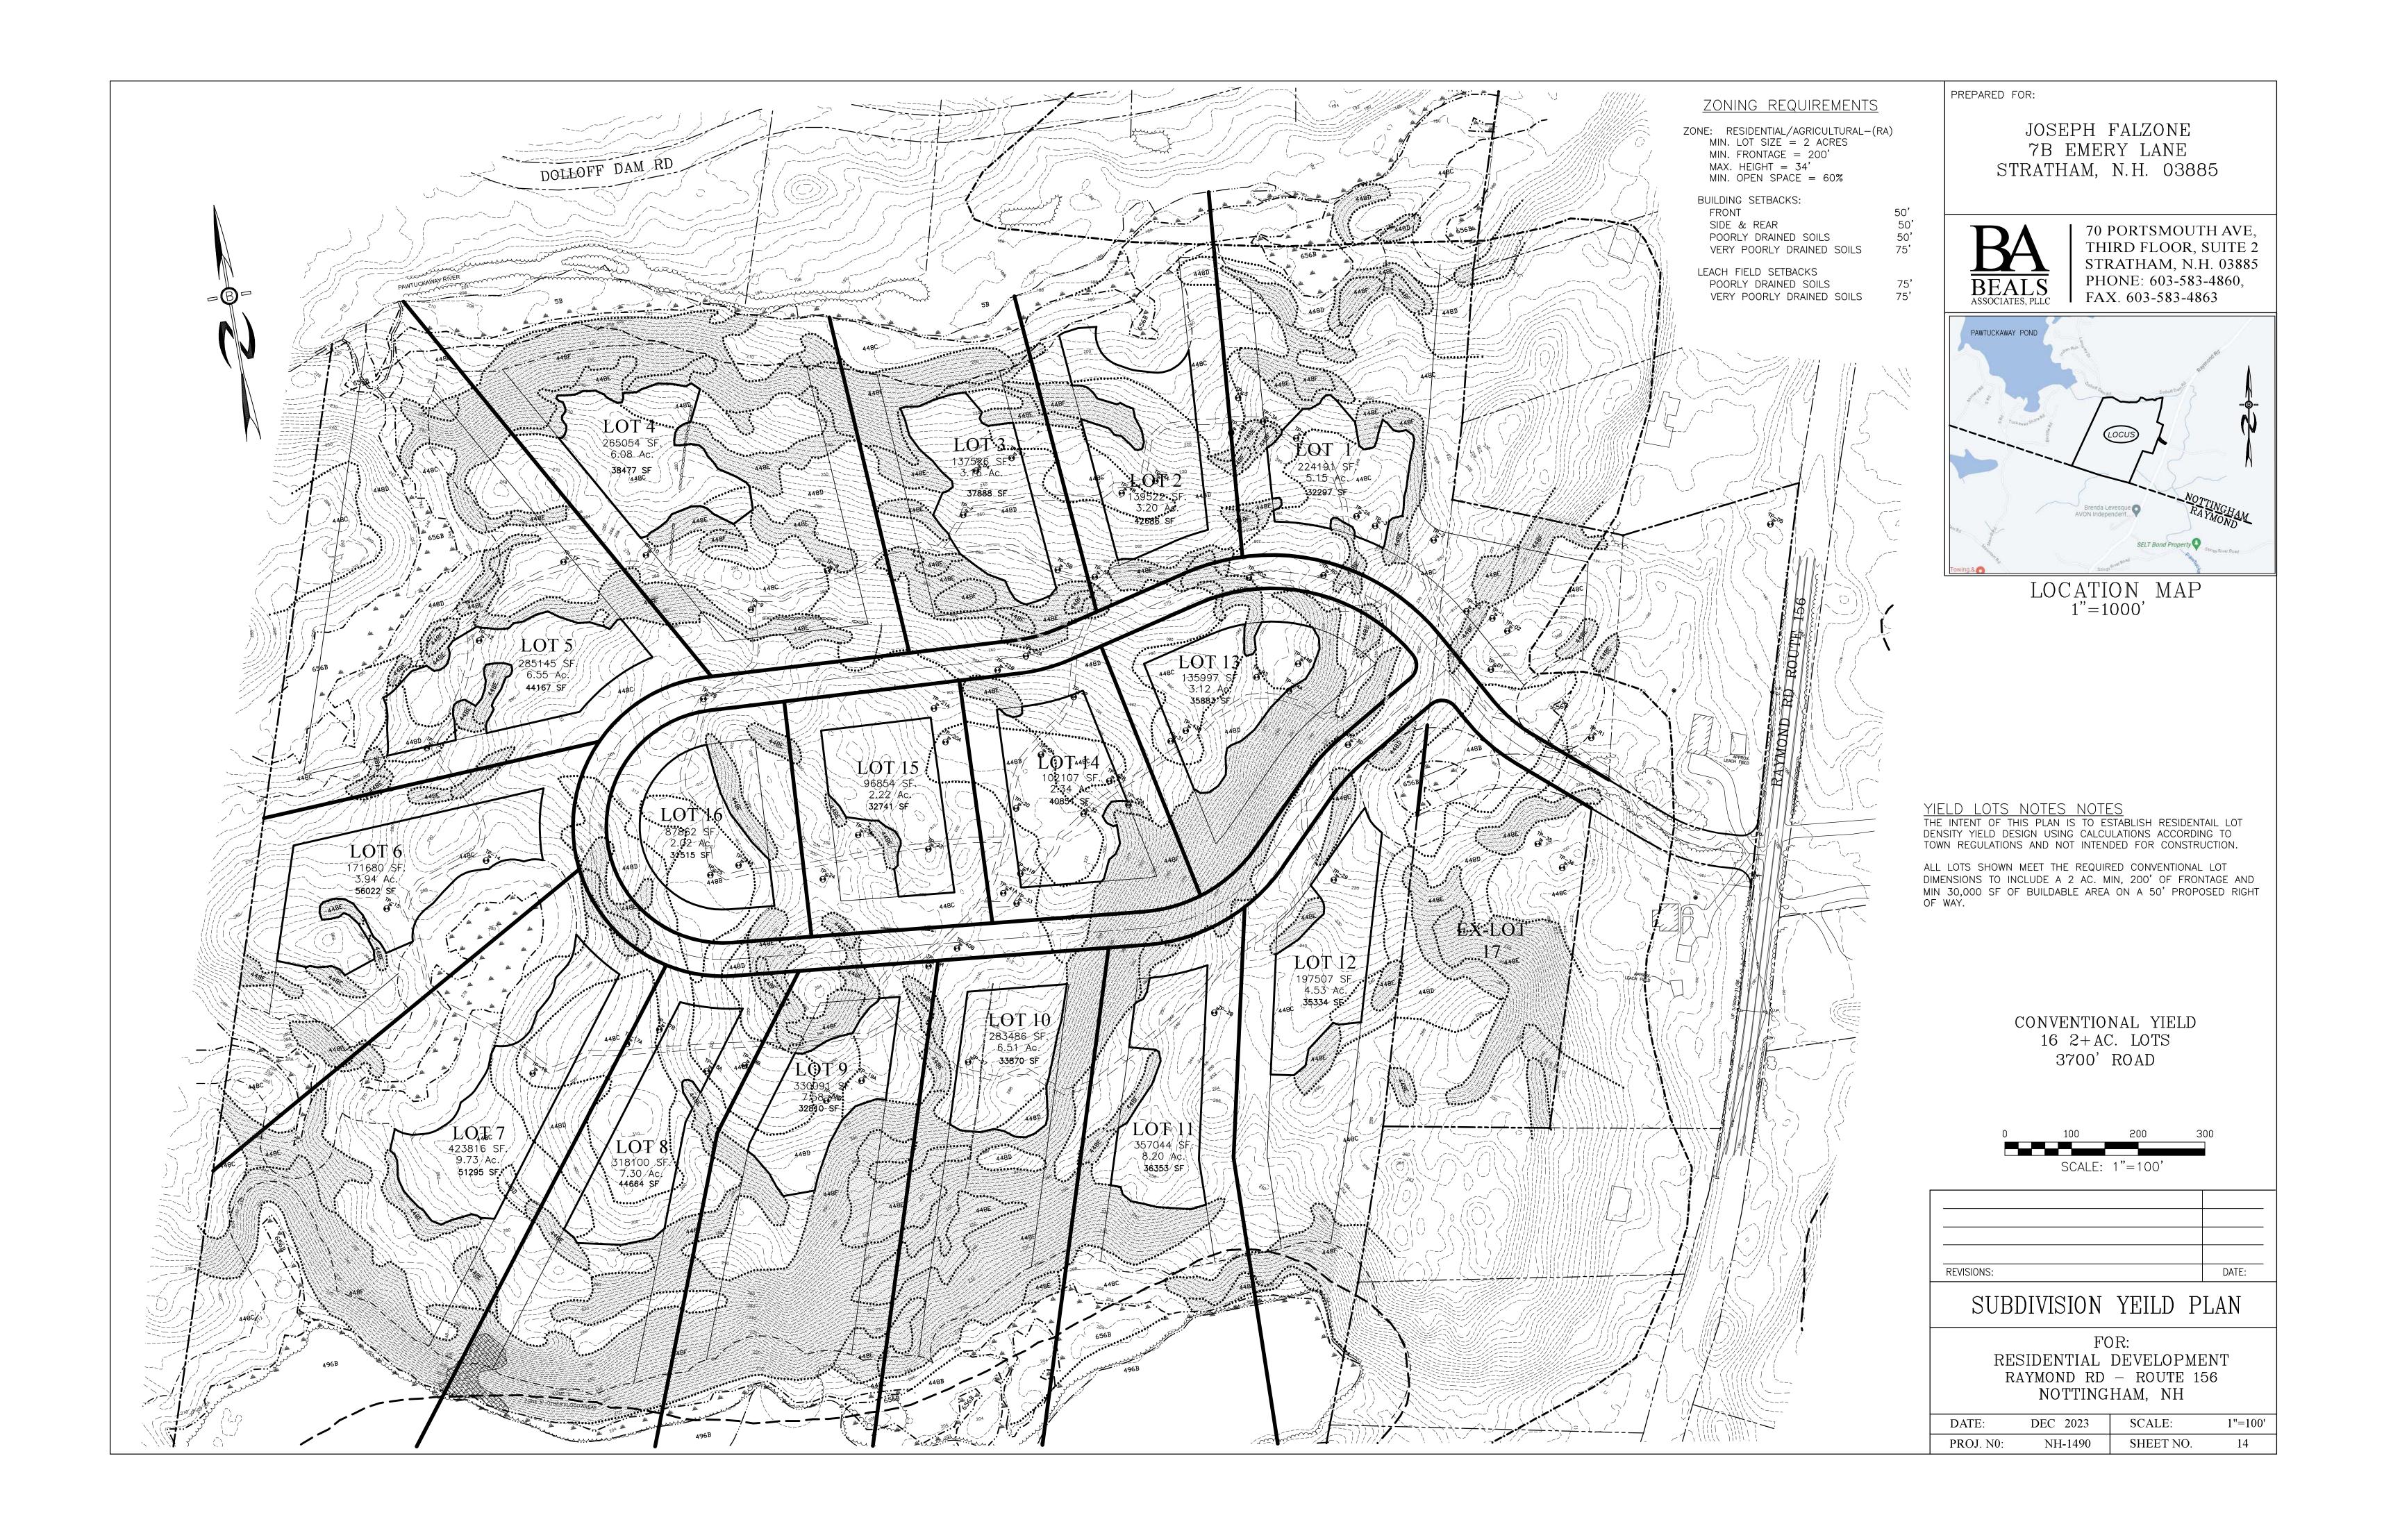


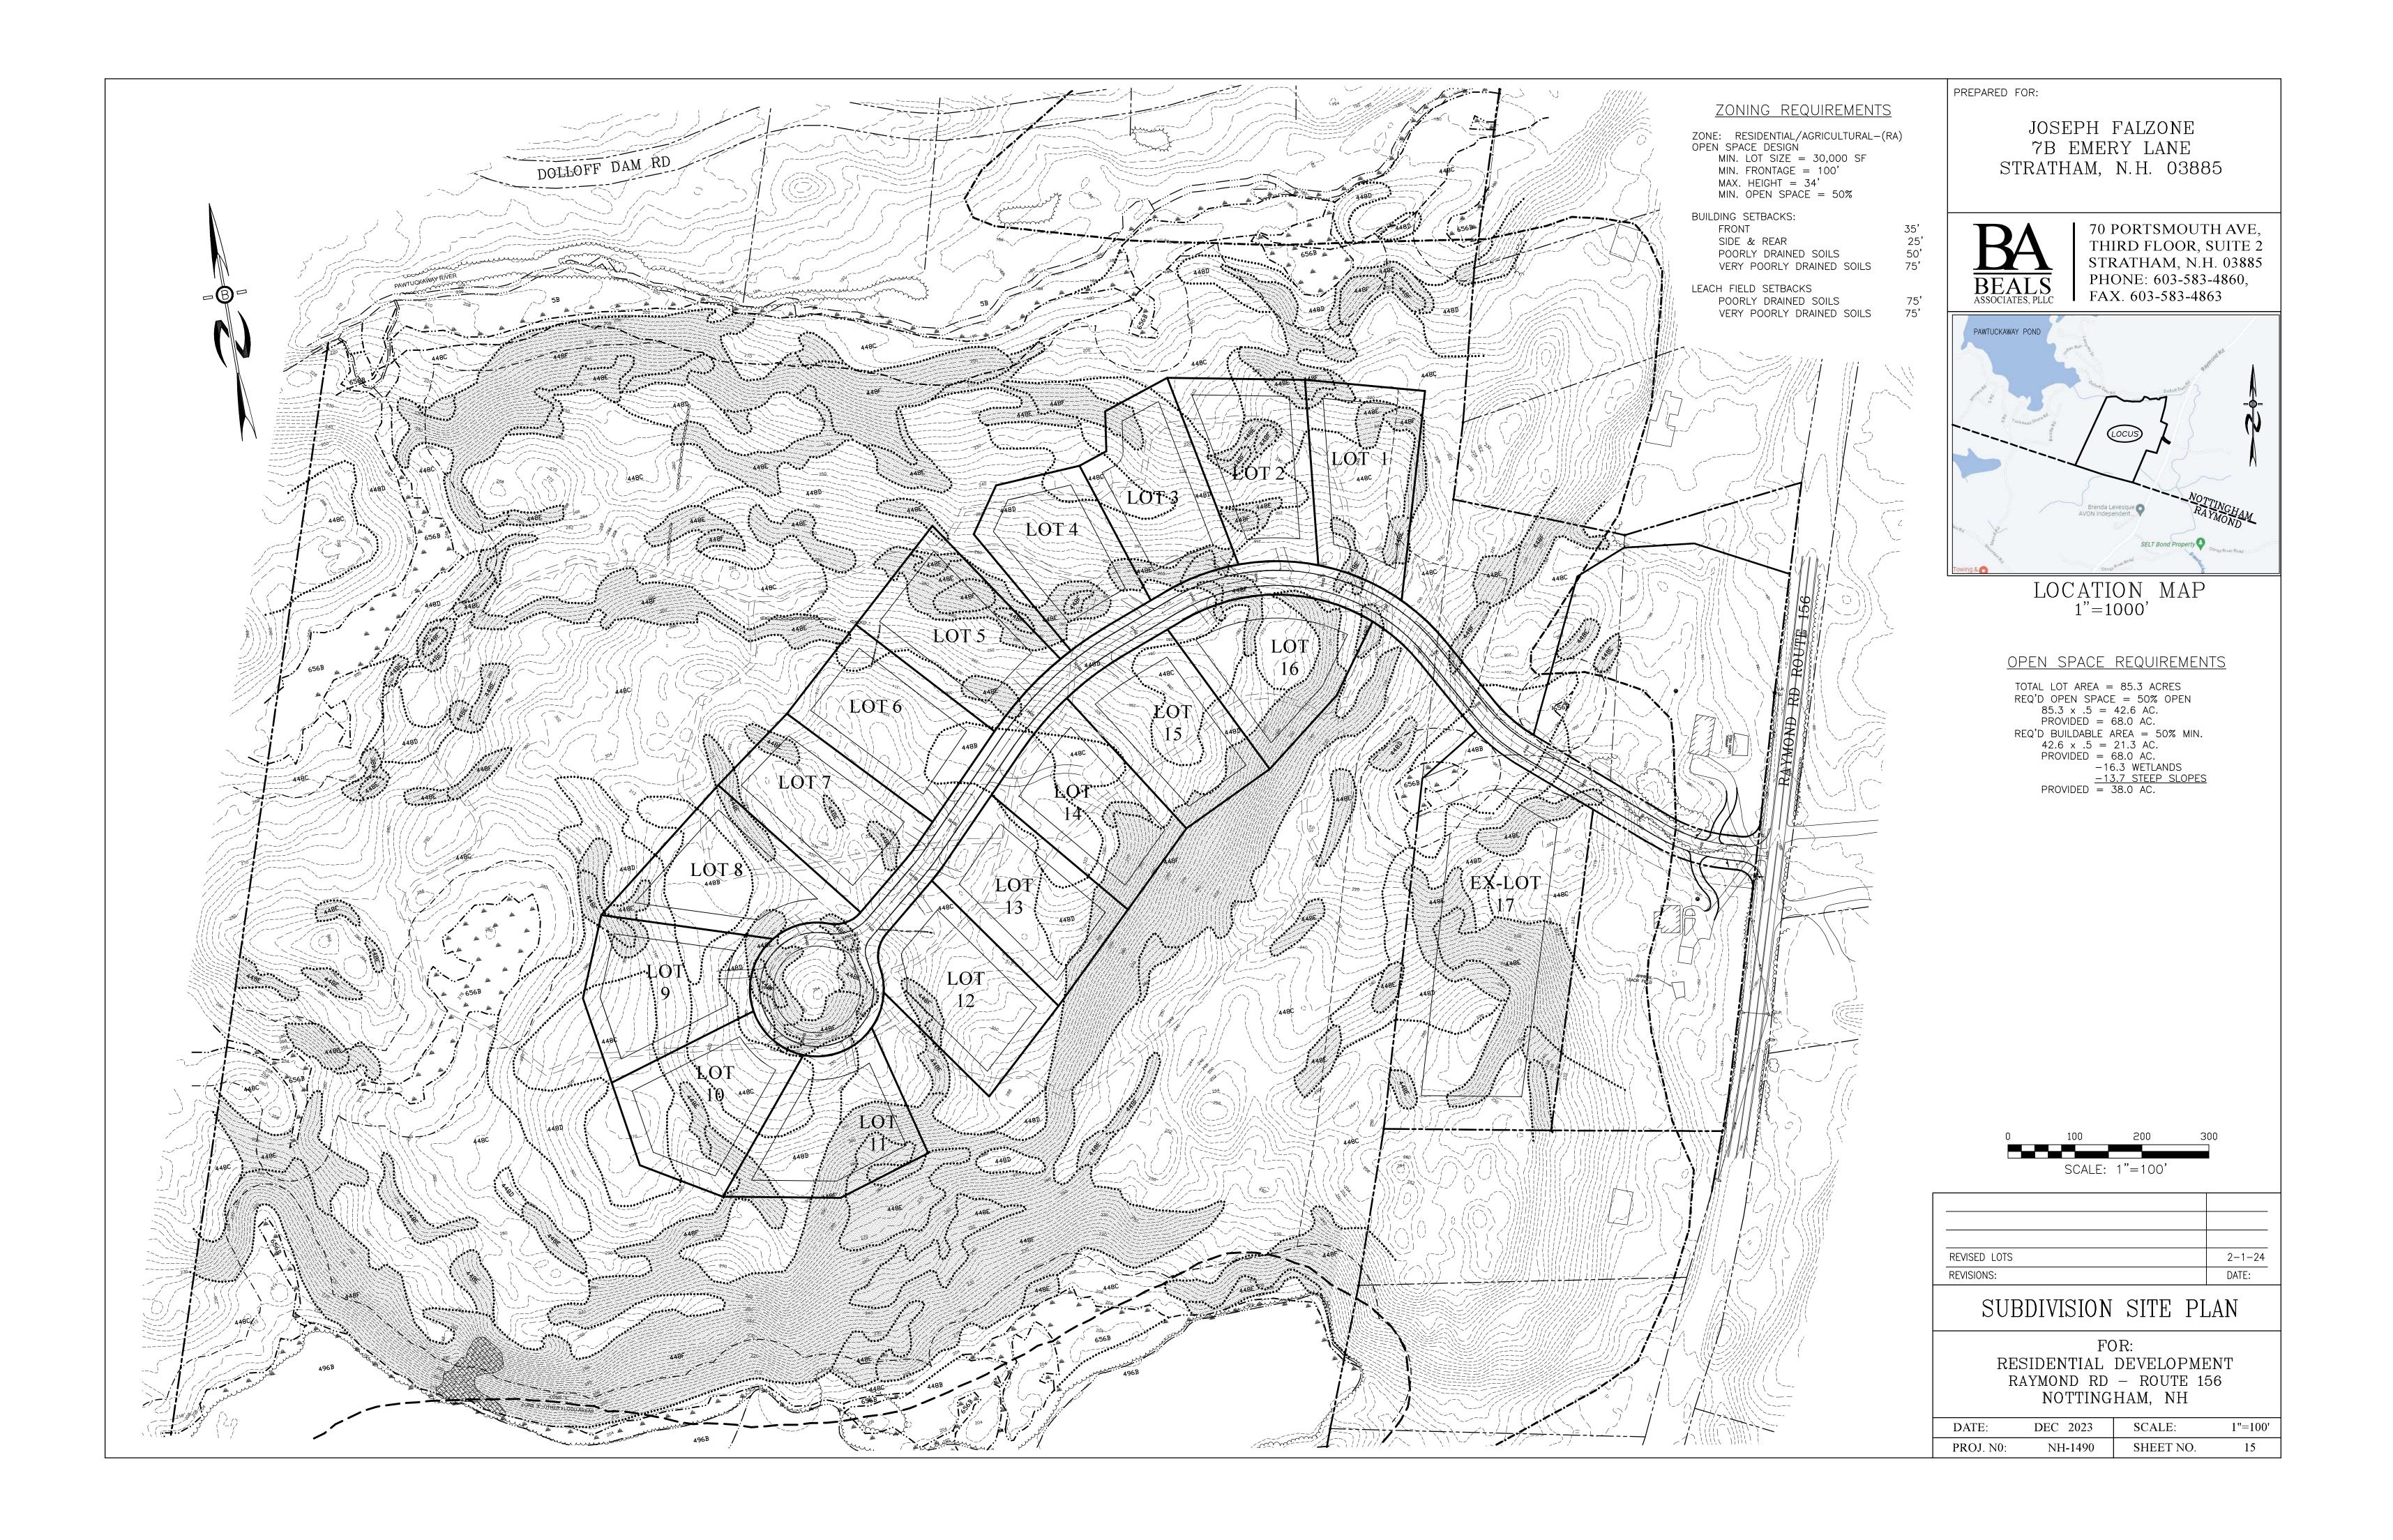


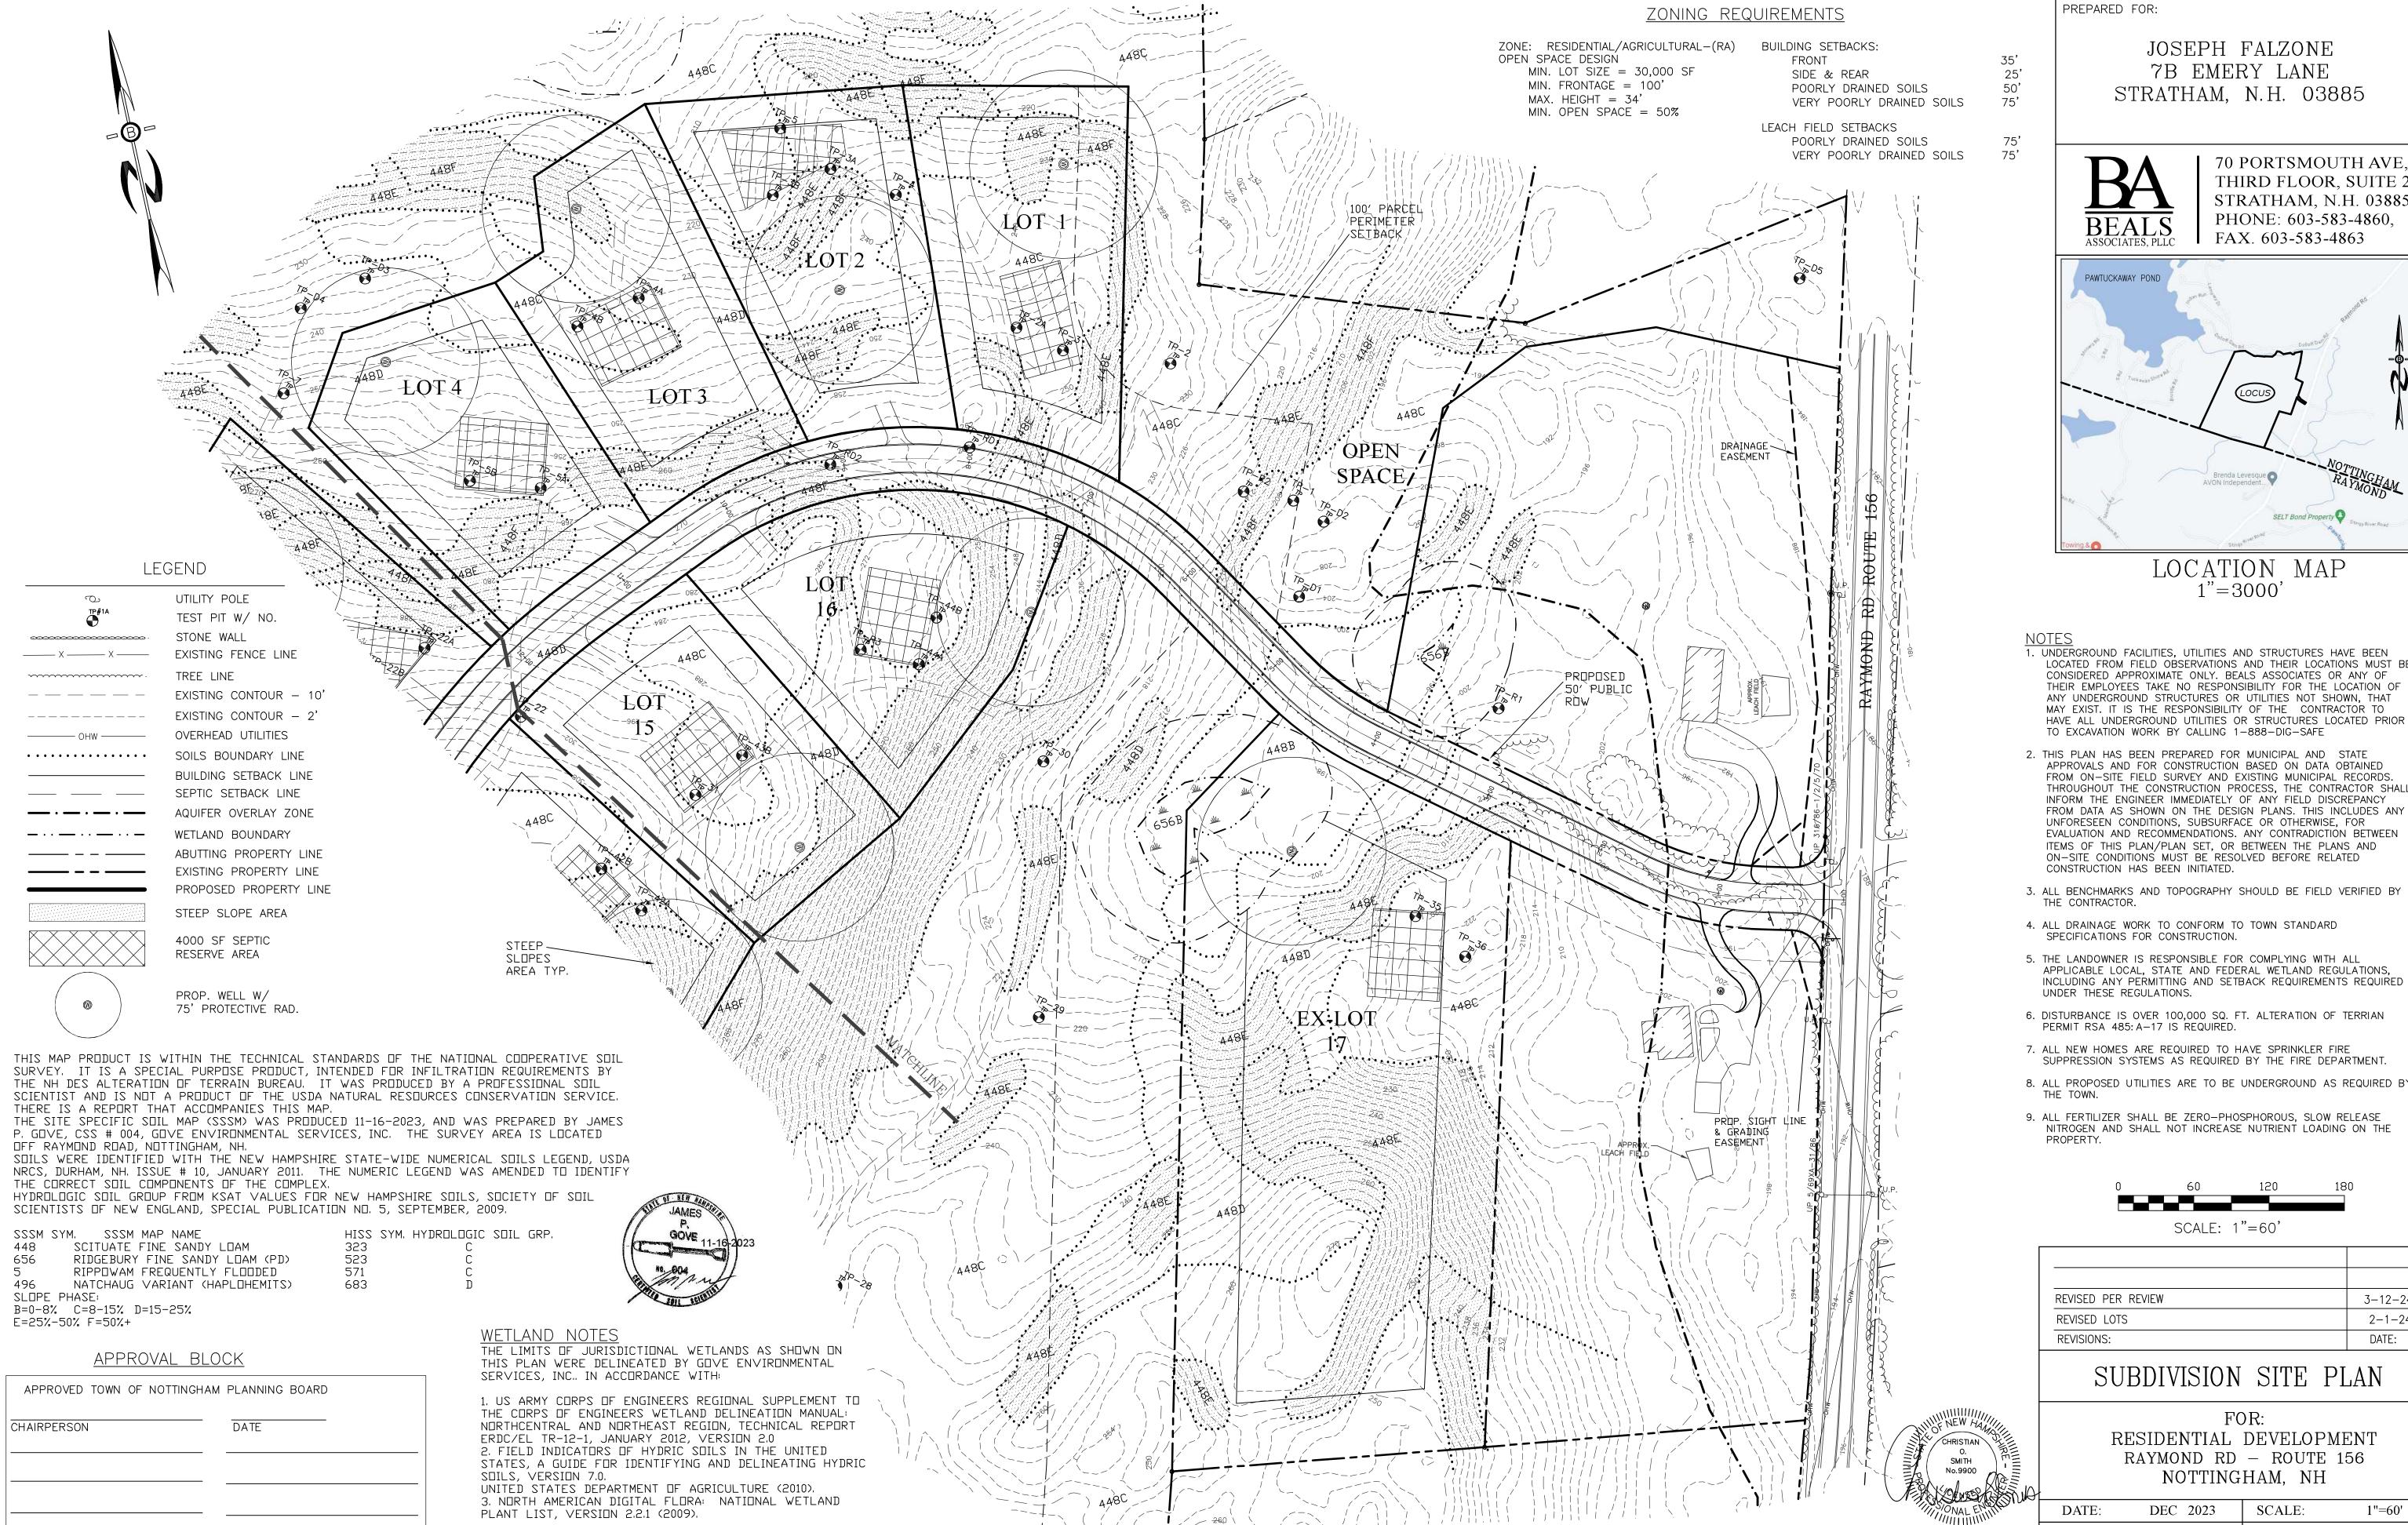












7B EMERY LANE

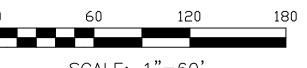
70 PORTSMOUTH AVE, THIRD FLOOR, SUITE 2 STRATHAM, N.H. 03885 PHONE: 603-583-4860, FAX. 603-583-4863



LOCATION MAP

- LOCATED FROM FIELD OBSERVATIONS AND THEIR LOCATIONS MUST BE CONSIDERED APPROXIMATE ONLY. BEALS ASSOCIATES OR ANY OF THEIR EMPLOYEES TAKE NO RESPONSIBILITY FOR THE LOCATION OF ANY UNDERGROUND STRUCTURES OR UTILITIES NOT SHOWN, THAT MAY EXIST. IT IS THE RESPONSIBILITY OF THE CONTRACTOR TO HAVE ALL UNDERGROUND UTILITIES OR STRUCTURES LOCATED PRIOR
- APPROVALS AND FOR CONSTRUCTION BASED ON DATA OBTAINED FROM ON-SITE FIELD SURVEY AND EXISTING MUNICIPAL RECORDS. THROUGHOUT THE CONSTRUCTION PROCESS, THE CONTRACTOR SHALL INFORM THE ENGINEER IMMEDIATELY OF ANY FIELD DISCREPANCY FROM DATA AS SHOWN ON THE DESIGN PLANS. THIS INCLUDES ANY UNFORESEEN CONDITIONS, SUBSURFACE OR OTHERWISE, FOR EVALUATION AND RECOMMENDATIONS. ANY CONTRADICTION BETWEEN ITEMS OF THIS PLAN/PLAN SET. OR BETWEEN THE PLANS AND ON-SITE CONDITIONS MUST BE RESOLVED BEFORE RELATED


- 5. THE LANDOWNER IS RESPONSIBLE FOR COMPLYING WITH ALL APPLICABLE LOCAL, STATE AND FEDERAL WETLAND REGULATIONS, INCLUDING ANY PERMITTING AND SETBACK REQUIREMENTS REQUIRED
- 6. DISTURBANCE IS OVER 100,000 SQ. FT. ALTERATION OF TERRIAN
- 8. ALL PROPOSED UTILITIES ARE TO BE UNDERGROUND AS REQUIRED BY
- NITROGEN AND SHALL NOT INCREASE NUTRIENT LOADING ON THE





REVISED PER REVIEW	3-12-24
REVISED LOTS	2-1-24
REVISIONS:	DATE:

RESIDENTIAL DEVELOPMENT RAYMOND RD - ROUTE 156

DATE:	DEC 2023	SCALE:	1"=60'
PROJ. N0:	NH-1490	SHEET NO.	16

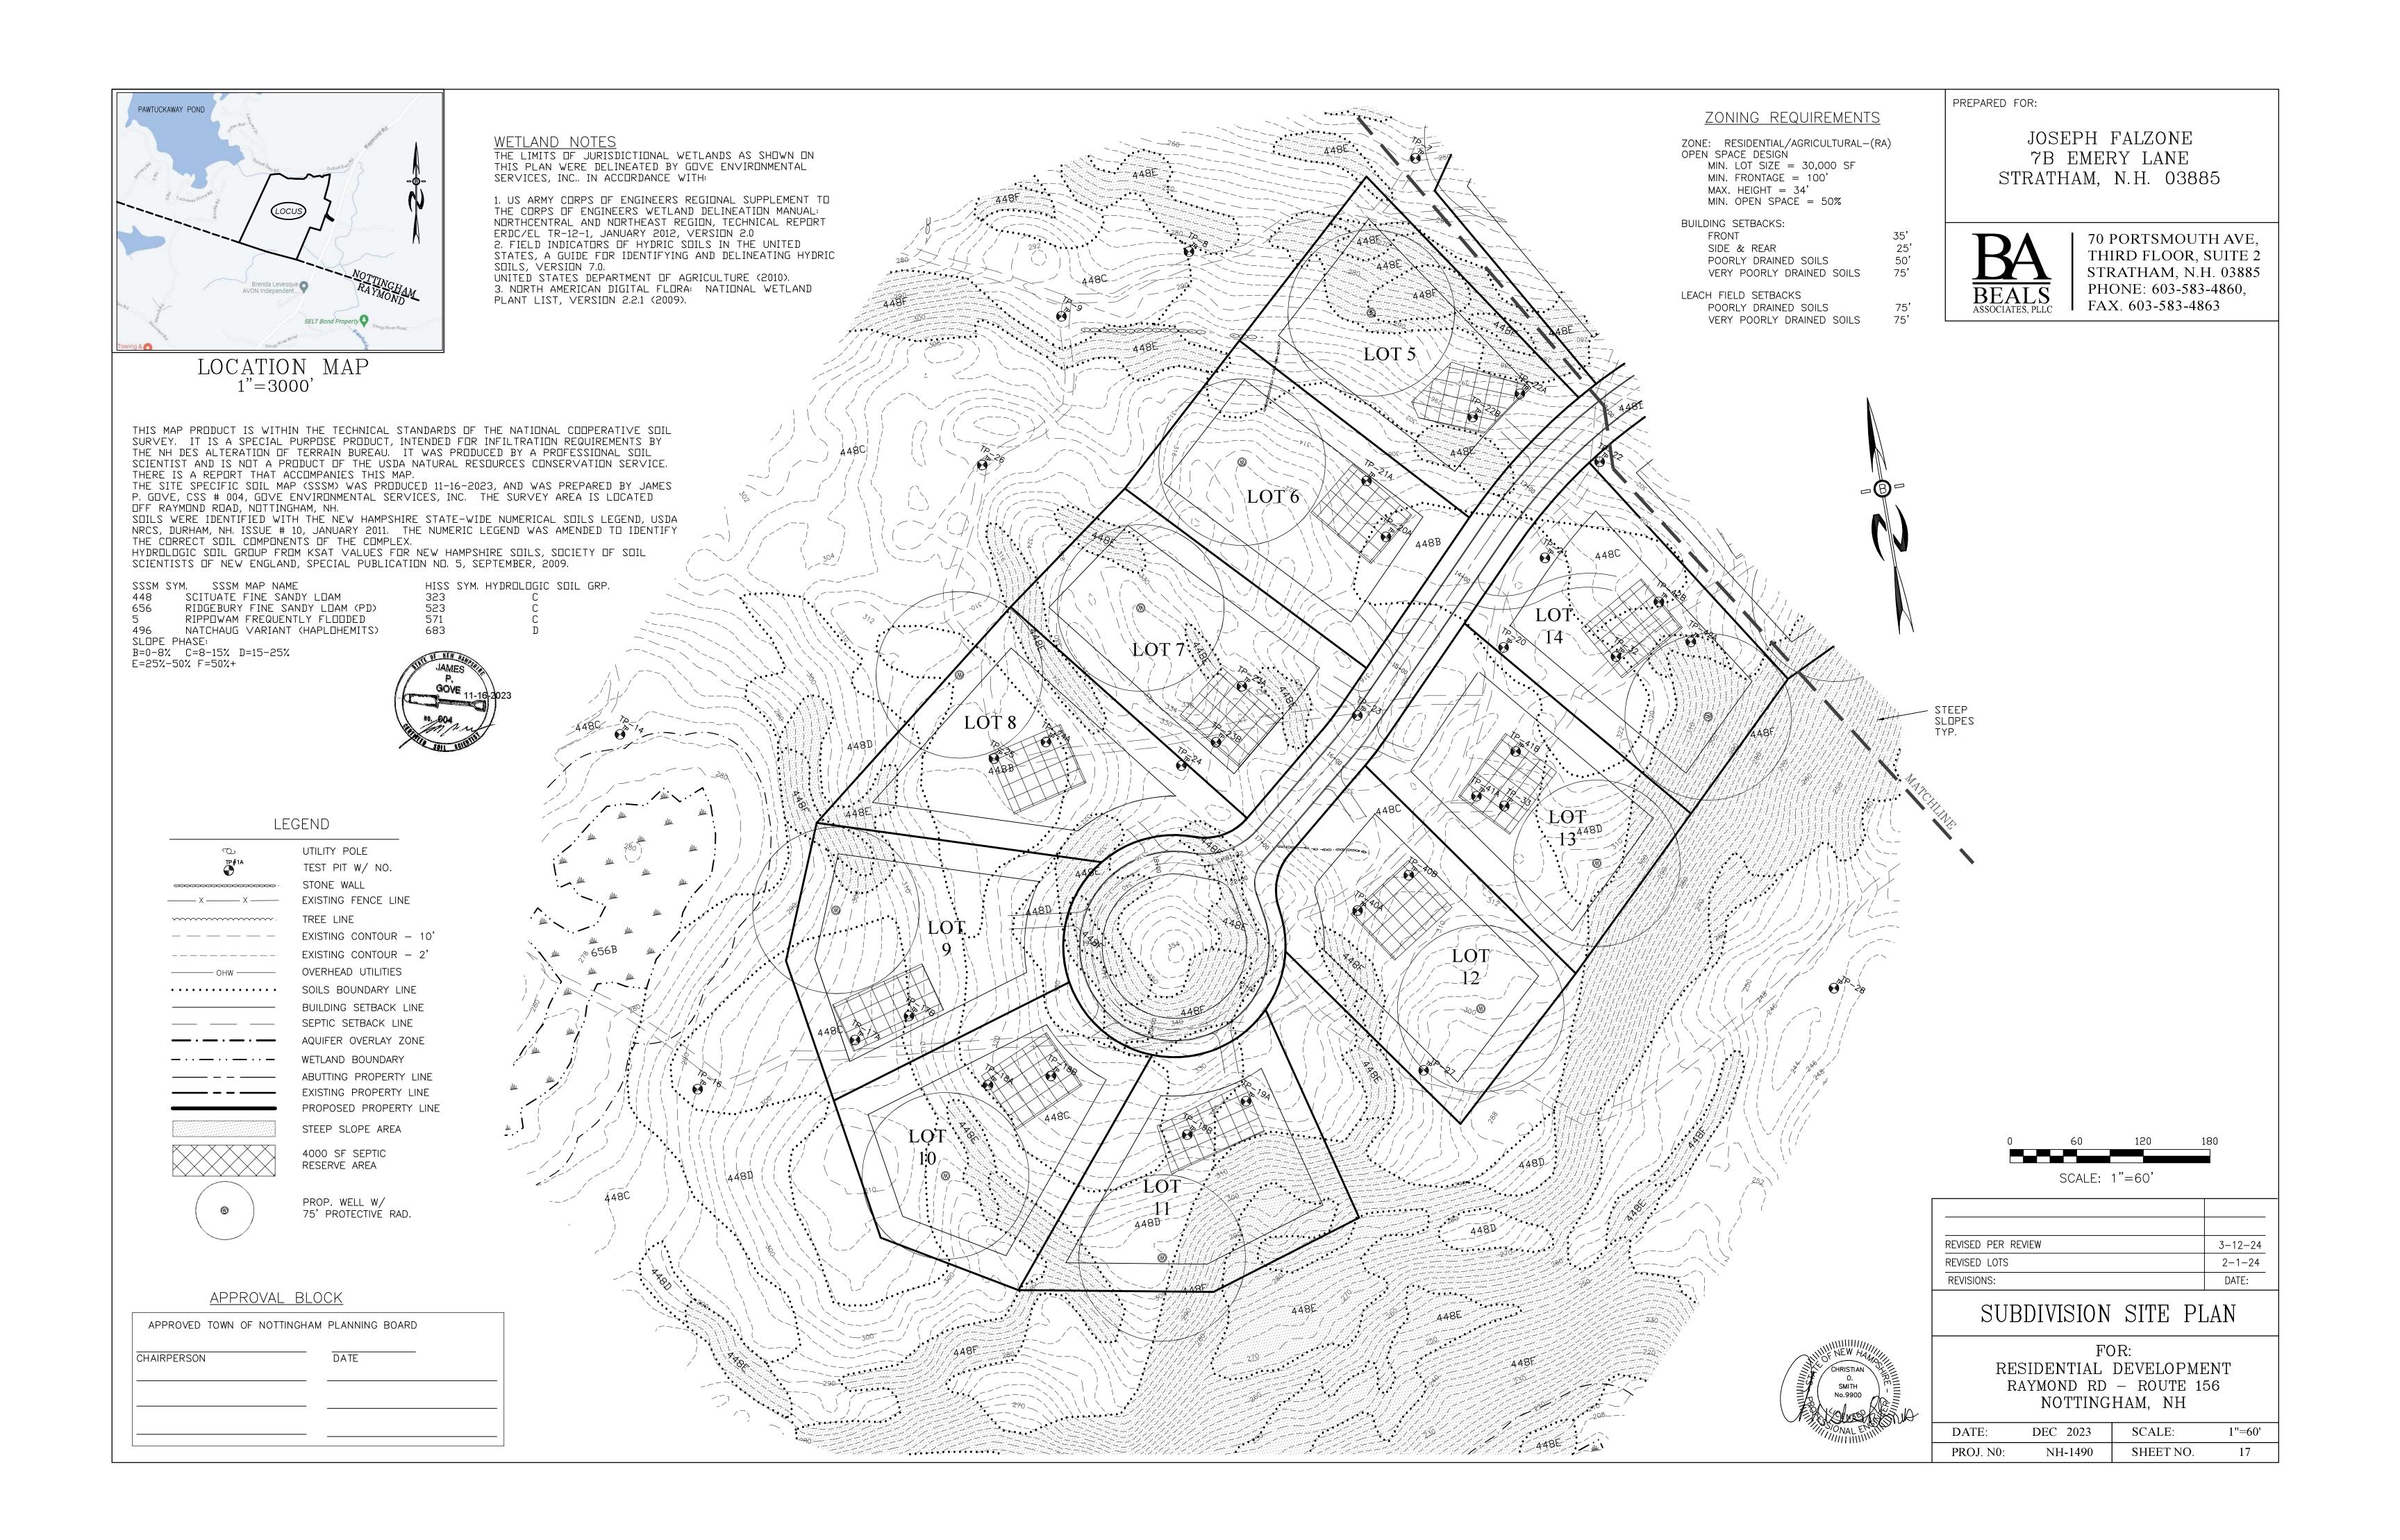

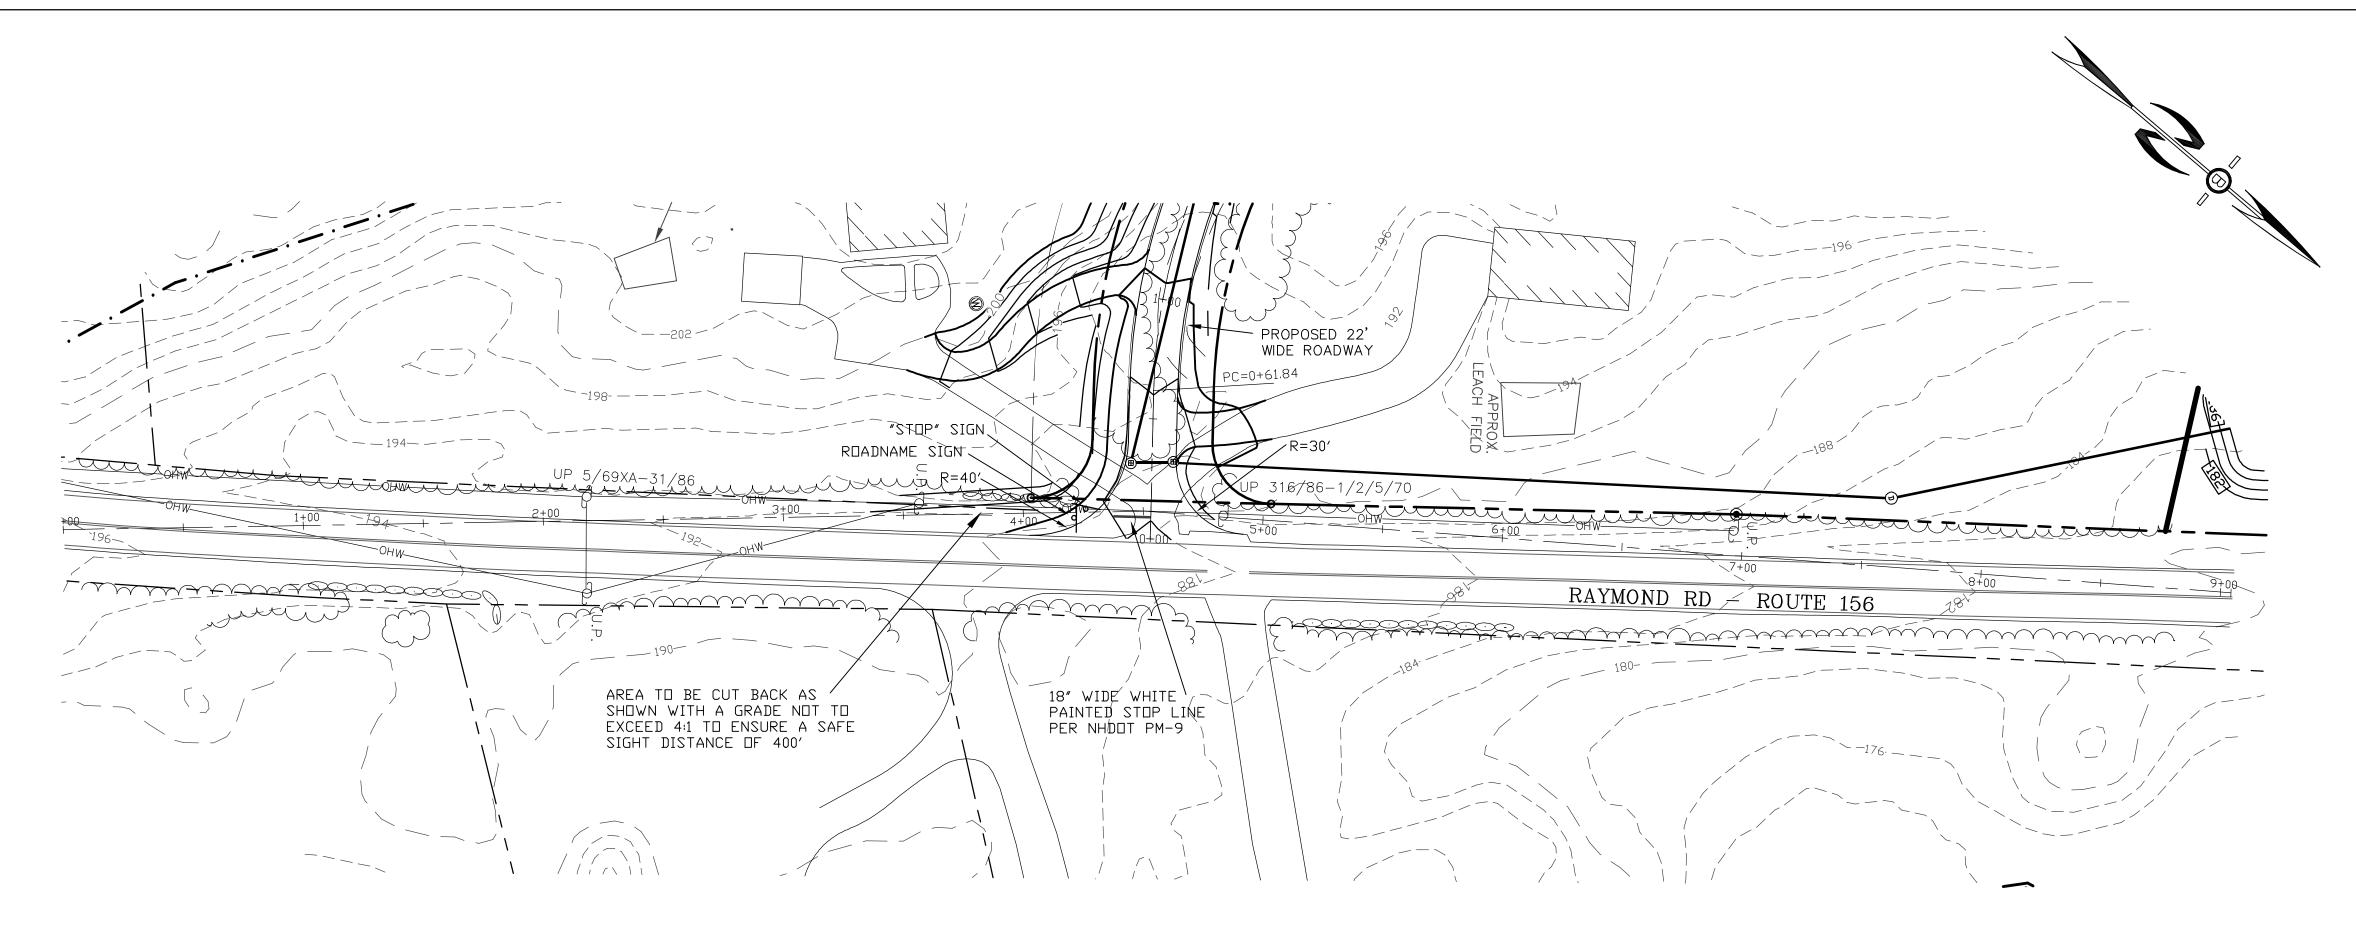


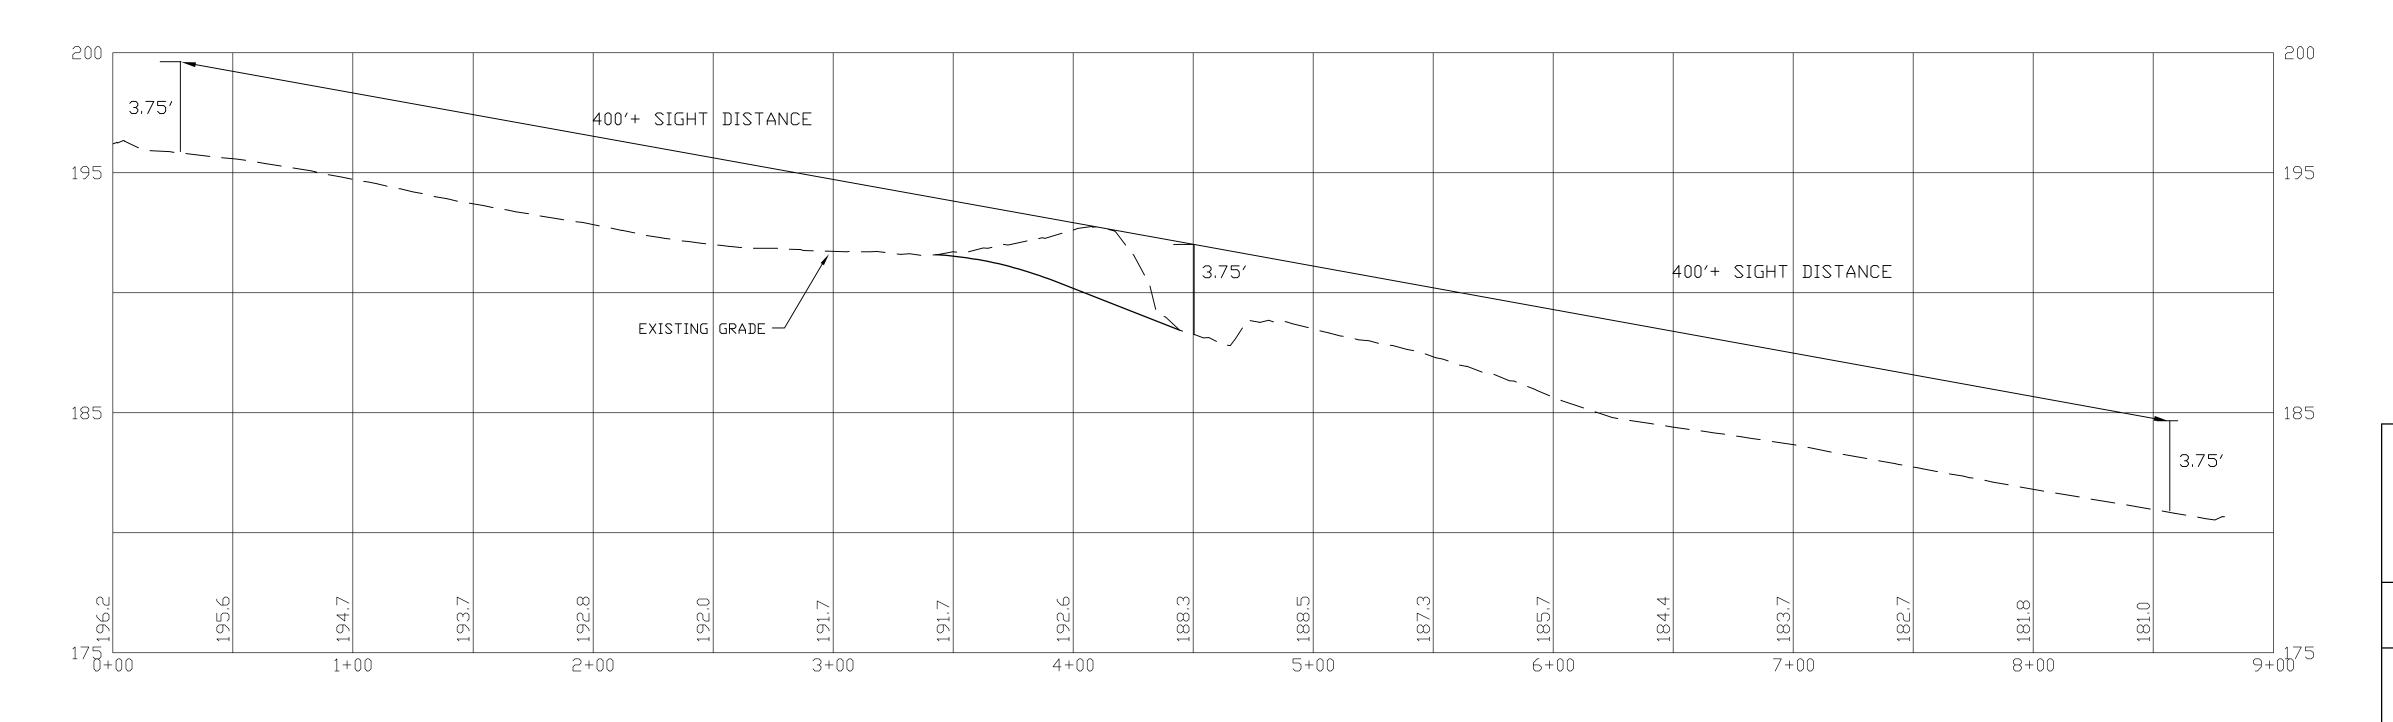

JOSEPH FALZONE 7B EMERY LANE STRATHAM, N.H. 03885



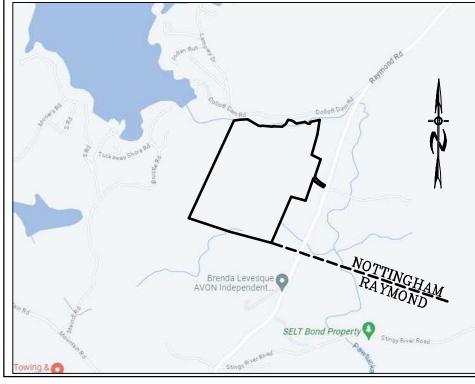70 PORTSMOUTH AVE, THIRD FLOOR, SUITE 2 STRATHAM, N.H. 03885 PHONE: 603-583-4860, FAX. 603-583-4863




LOCATION MAP 1"=1000"

ΝΠΤΕ

- 1. ALL ELECTRICAL, TELEPHONE, CABLE TELEVISION AND ALARM LINES TO BE UNDERGROUND. THE SIZE AND LOCATION IS TO BE DETERMINED BY APPROPRIATE UTILITY COMPANY
- UTILITY COMPANY.

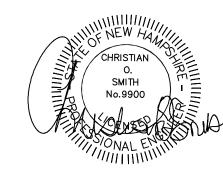 2. ALL BENCHMARKS AND TOPOGRAPHY SHOULD BE FIELD VERIFIED BY THE CONTRACTOR, ENGINEER TO BE NOTIFIED IMMEDIATELY OF ANY DISCREPANCY.
- 3. ALL CONSTRUCTION METHODS AND MATERIALS WILL CONFORM TO THE TOWN STANDARD SPECIFICATIONS AND TO N.H.D.O.T. STANDARDS AND REGULATIONS.
- 4. ALL DRAINAGE STRUCTURE AND SWALES WILL BE BUILT AND STABILIZED PRIOR TO HAVING RUN-OFF DIRECTED
- 5. SEE DETAIL SHEETS FOR STANDARD CONSTRUCTION NOTES AND DETAILS.
- 6. PROPOSED UNDER DRAINS TO BE INSTALLED AS SHOWN ON THE TYPICAL ROAD CROSS SECTION DETAIL AND TIE INTO DRAINAGE STRUCTURES.




PROFILE SCALES:
HORIZONTAL: 1"=40' VERTICAL: 1"=4'

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•	

ROADWAY ACCESS PLAN


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PROJ. N0:	NH-1490	SHEET NO.	18

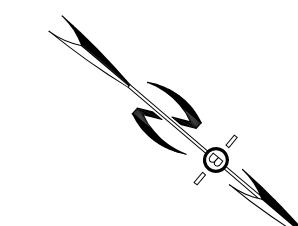


JOSEPH FALZONE 7B EMERY LANE STRATHAM, N.H. 03885



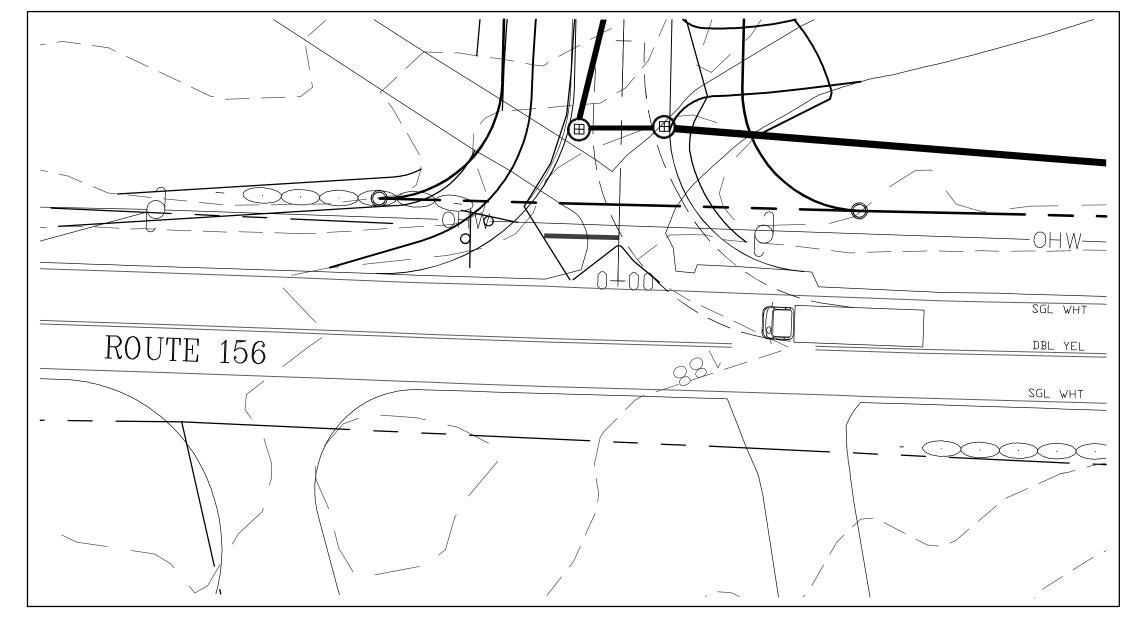
70 PORTSMOUTH AVE, THIRD FLOOR, SUITE 2 STRATHAM, N.H. 03885 PHONE: 603-583-4860, FAX. 603-583-4863



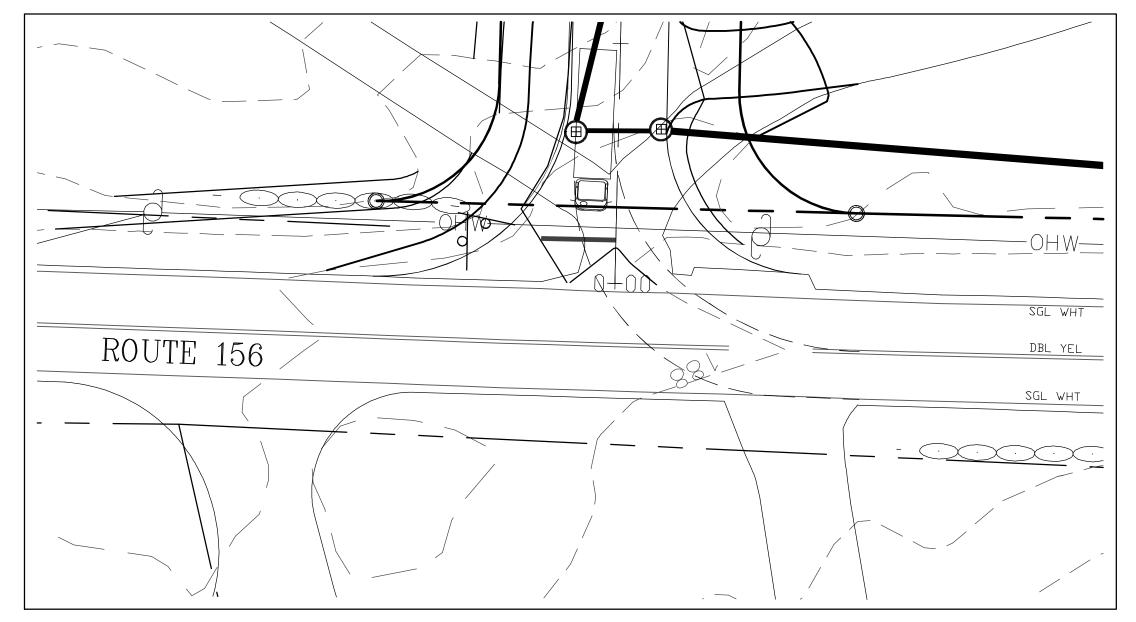
SU UTILITY TRUCK ENTERING SOUTHBOUND DETAIL SCALE: 1"=20'



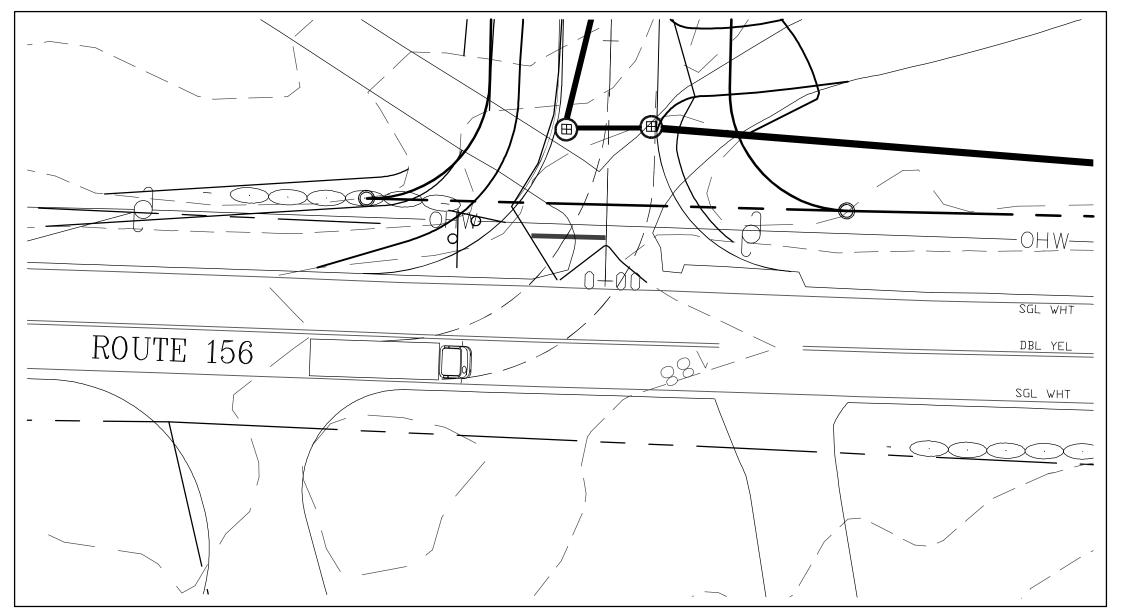
SU UTILITY TRUCK EXITING NORTHBOUND DETAIL SCALE: 1"=20'




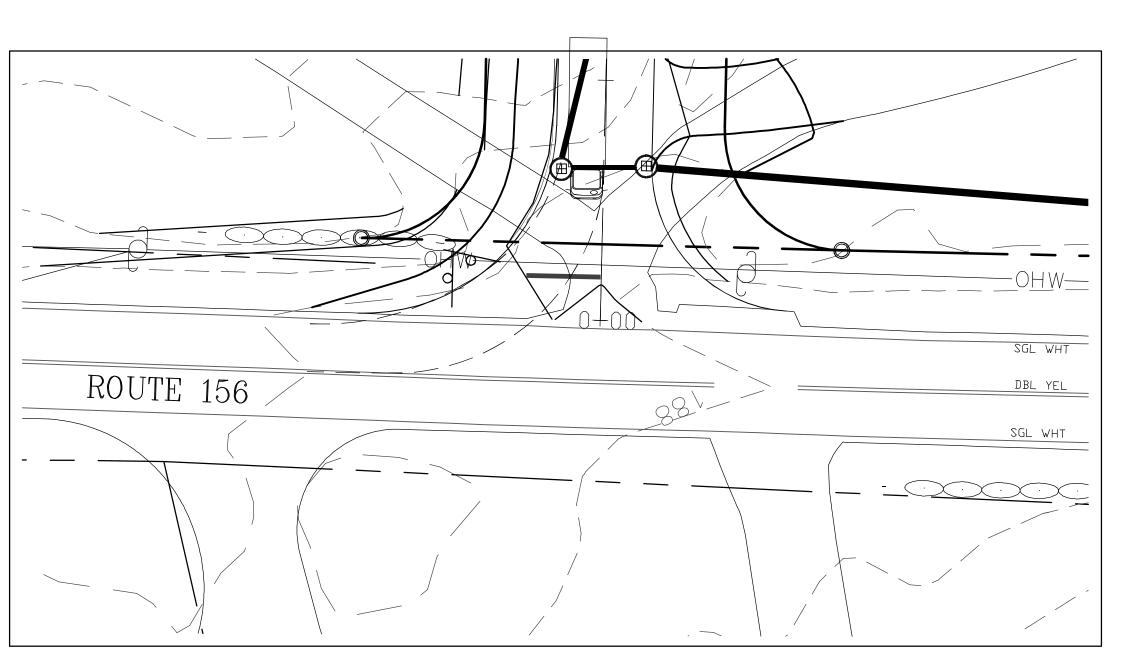SU UTILITY TRUCK ENTERING NORTHBOUND DETAIL SCALE: 1"=20'



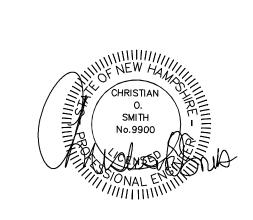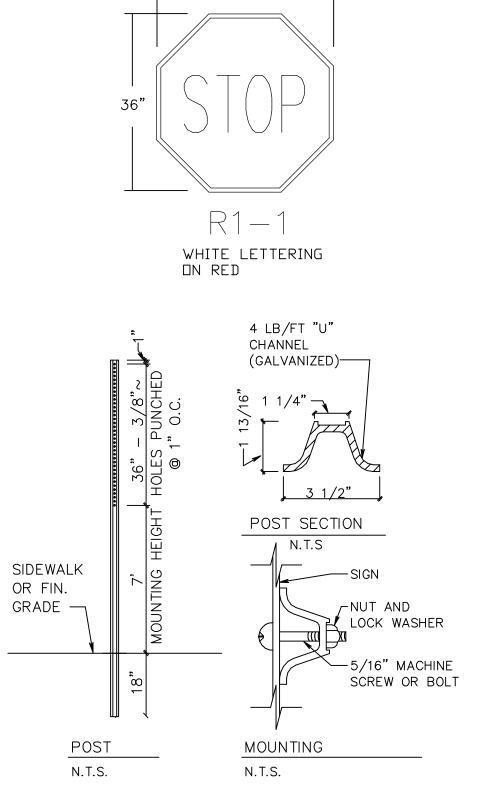SU UTILITY TRUCK EXITING SOUTHBOUND DETAIL SCALE: 1"=20'



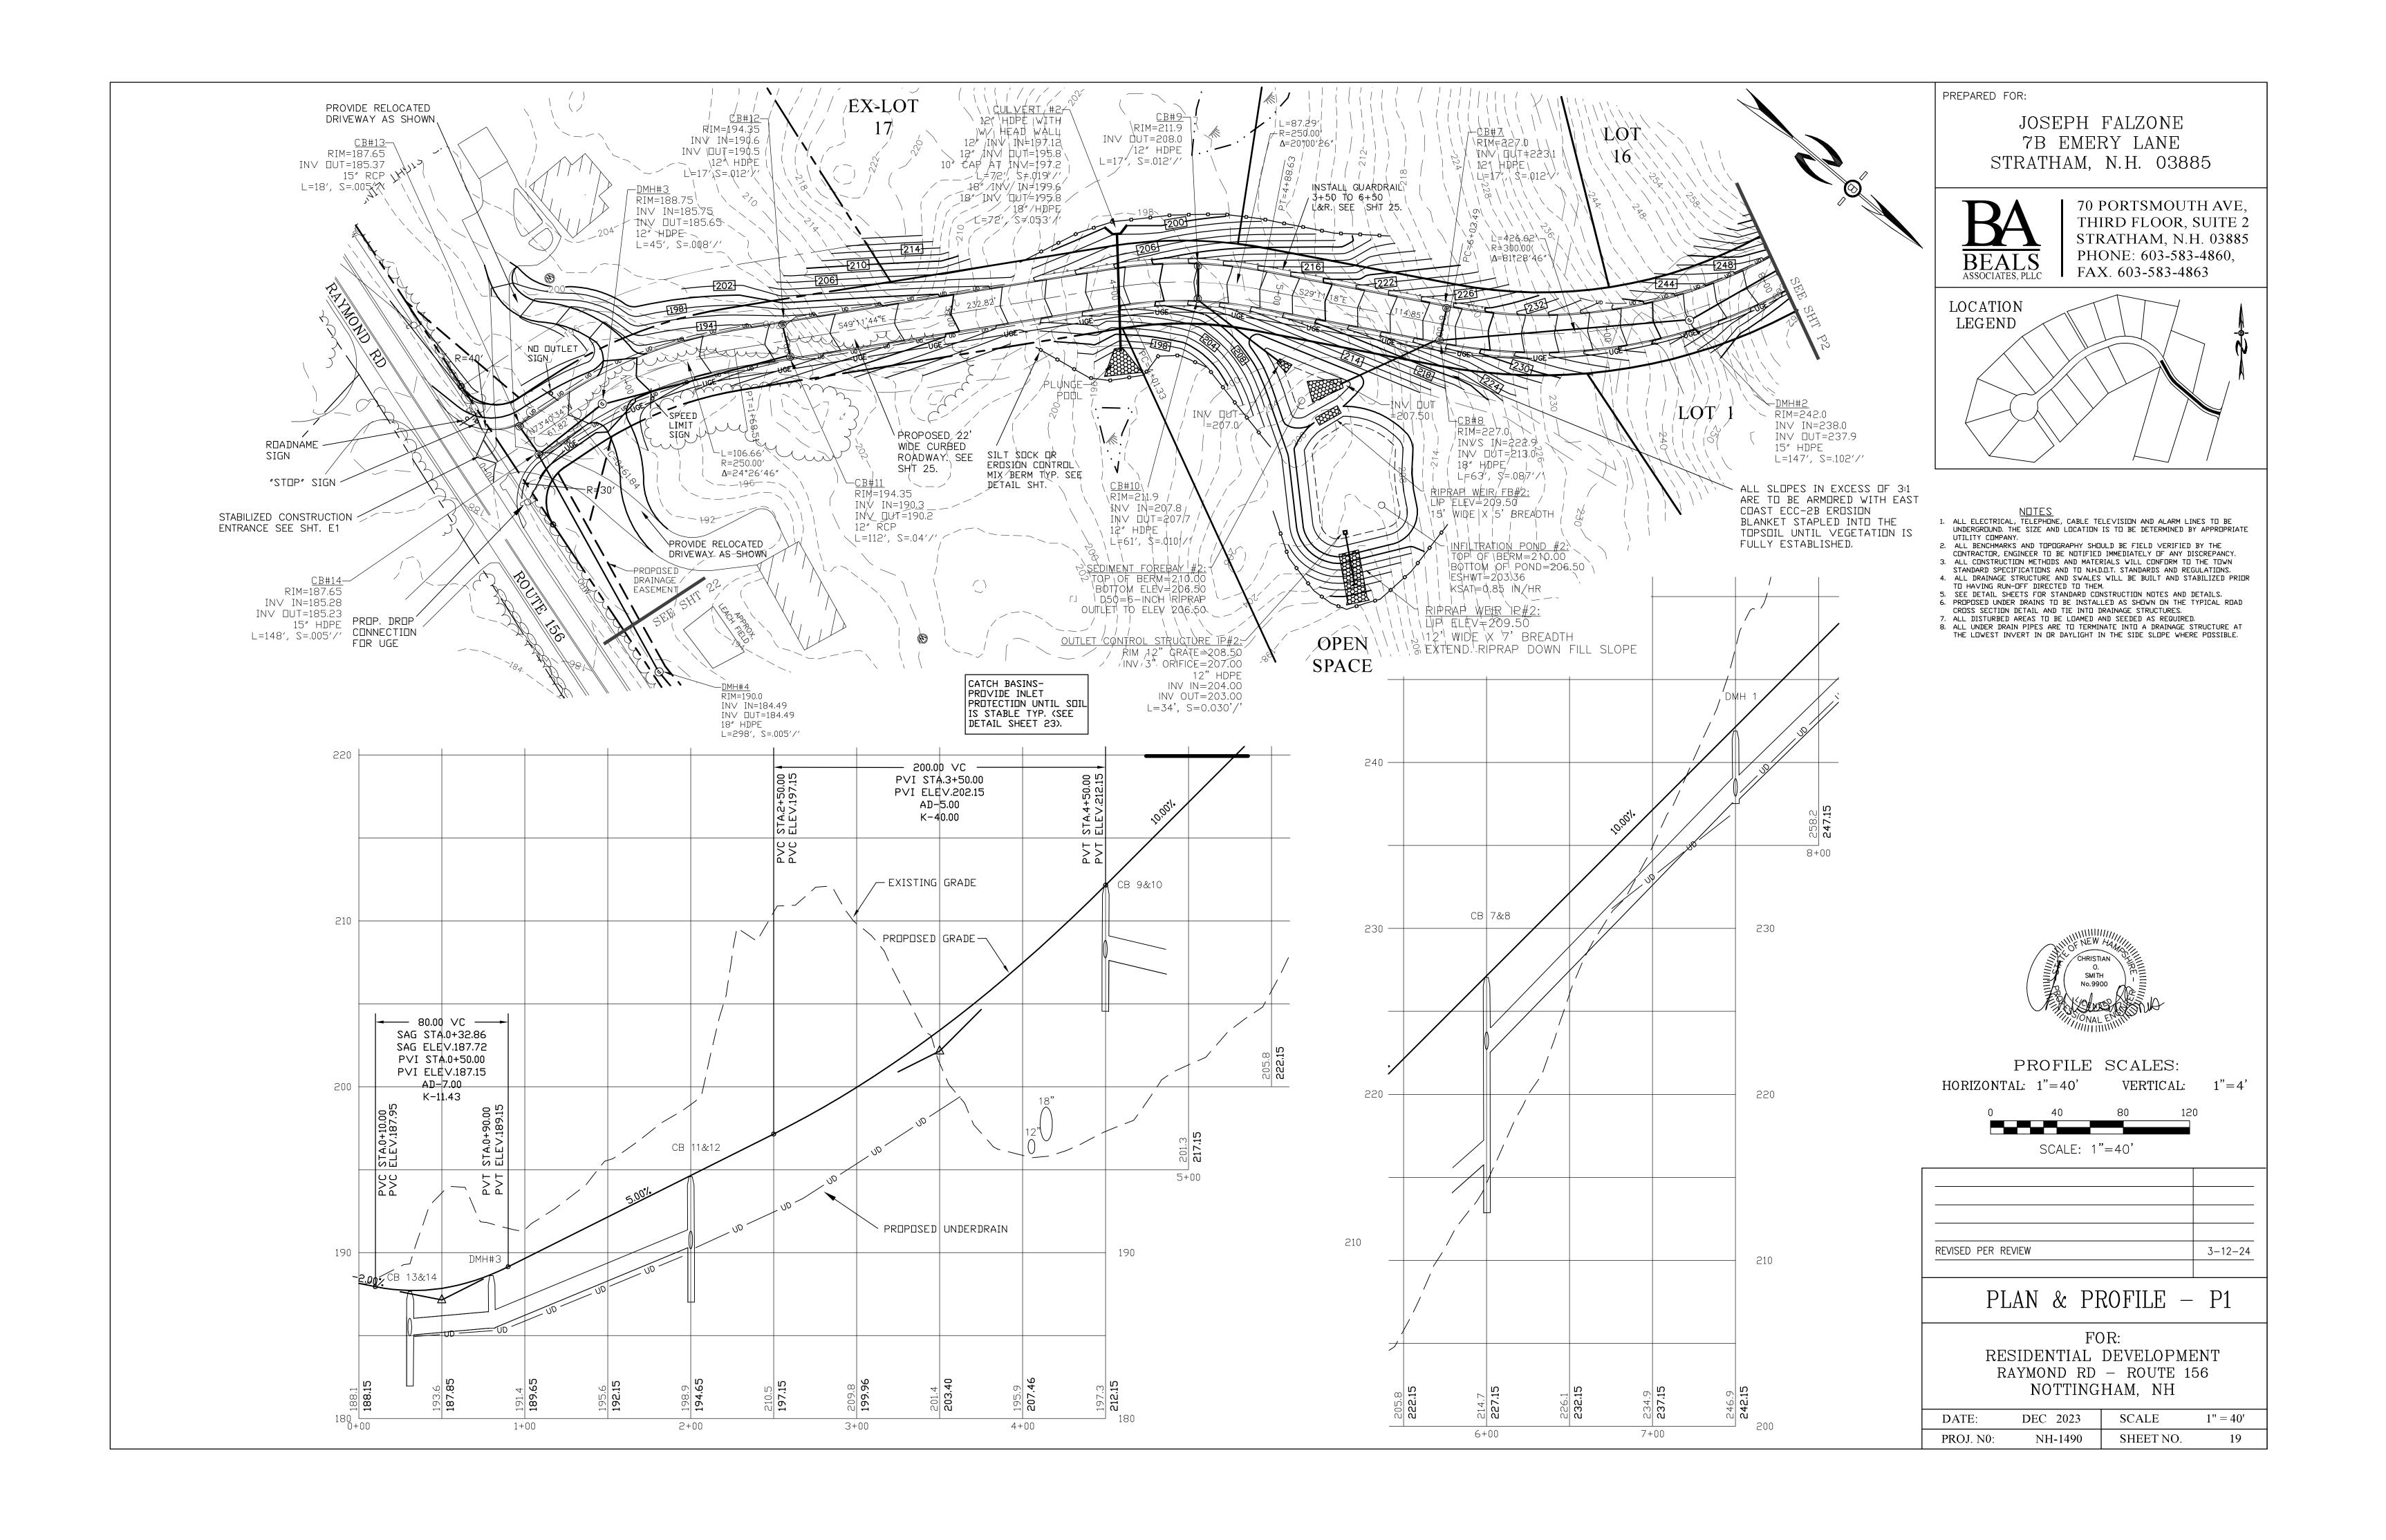


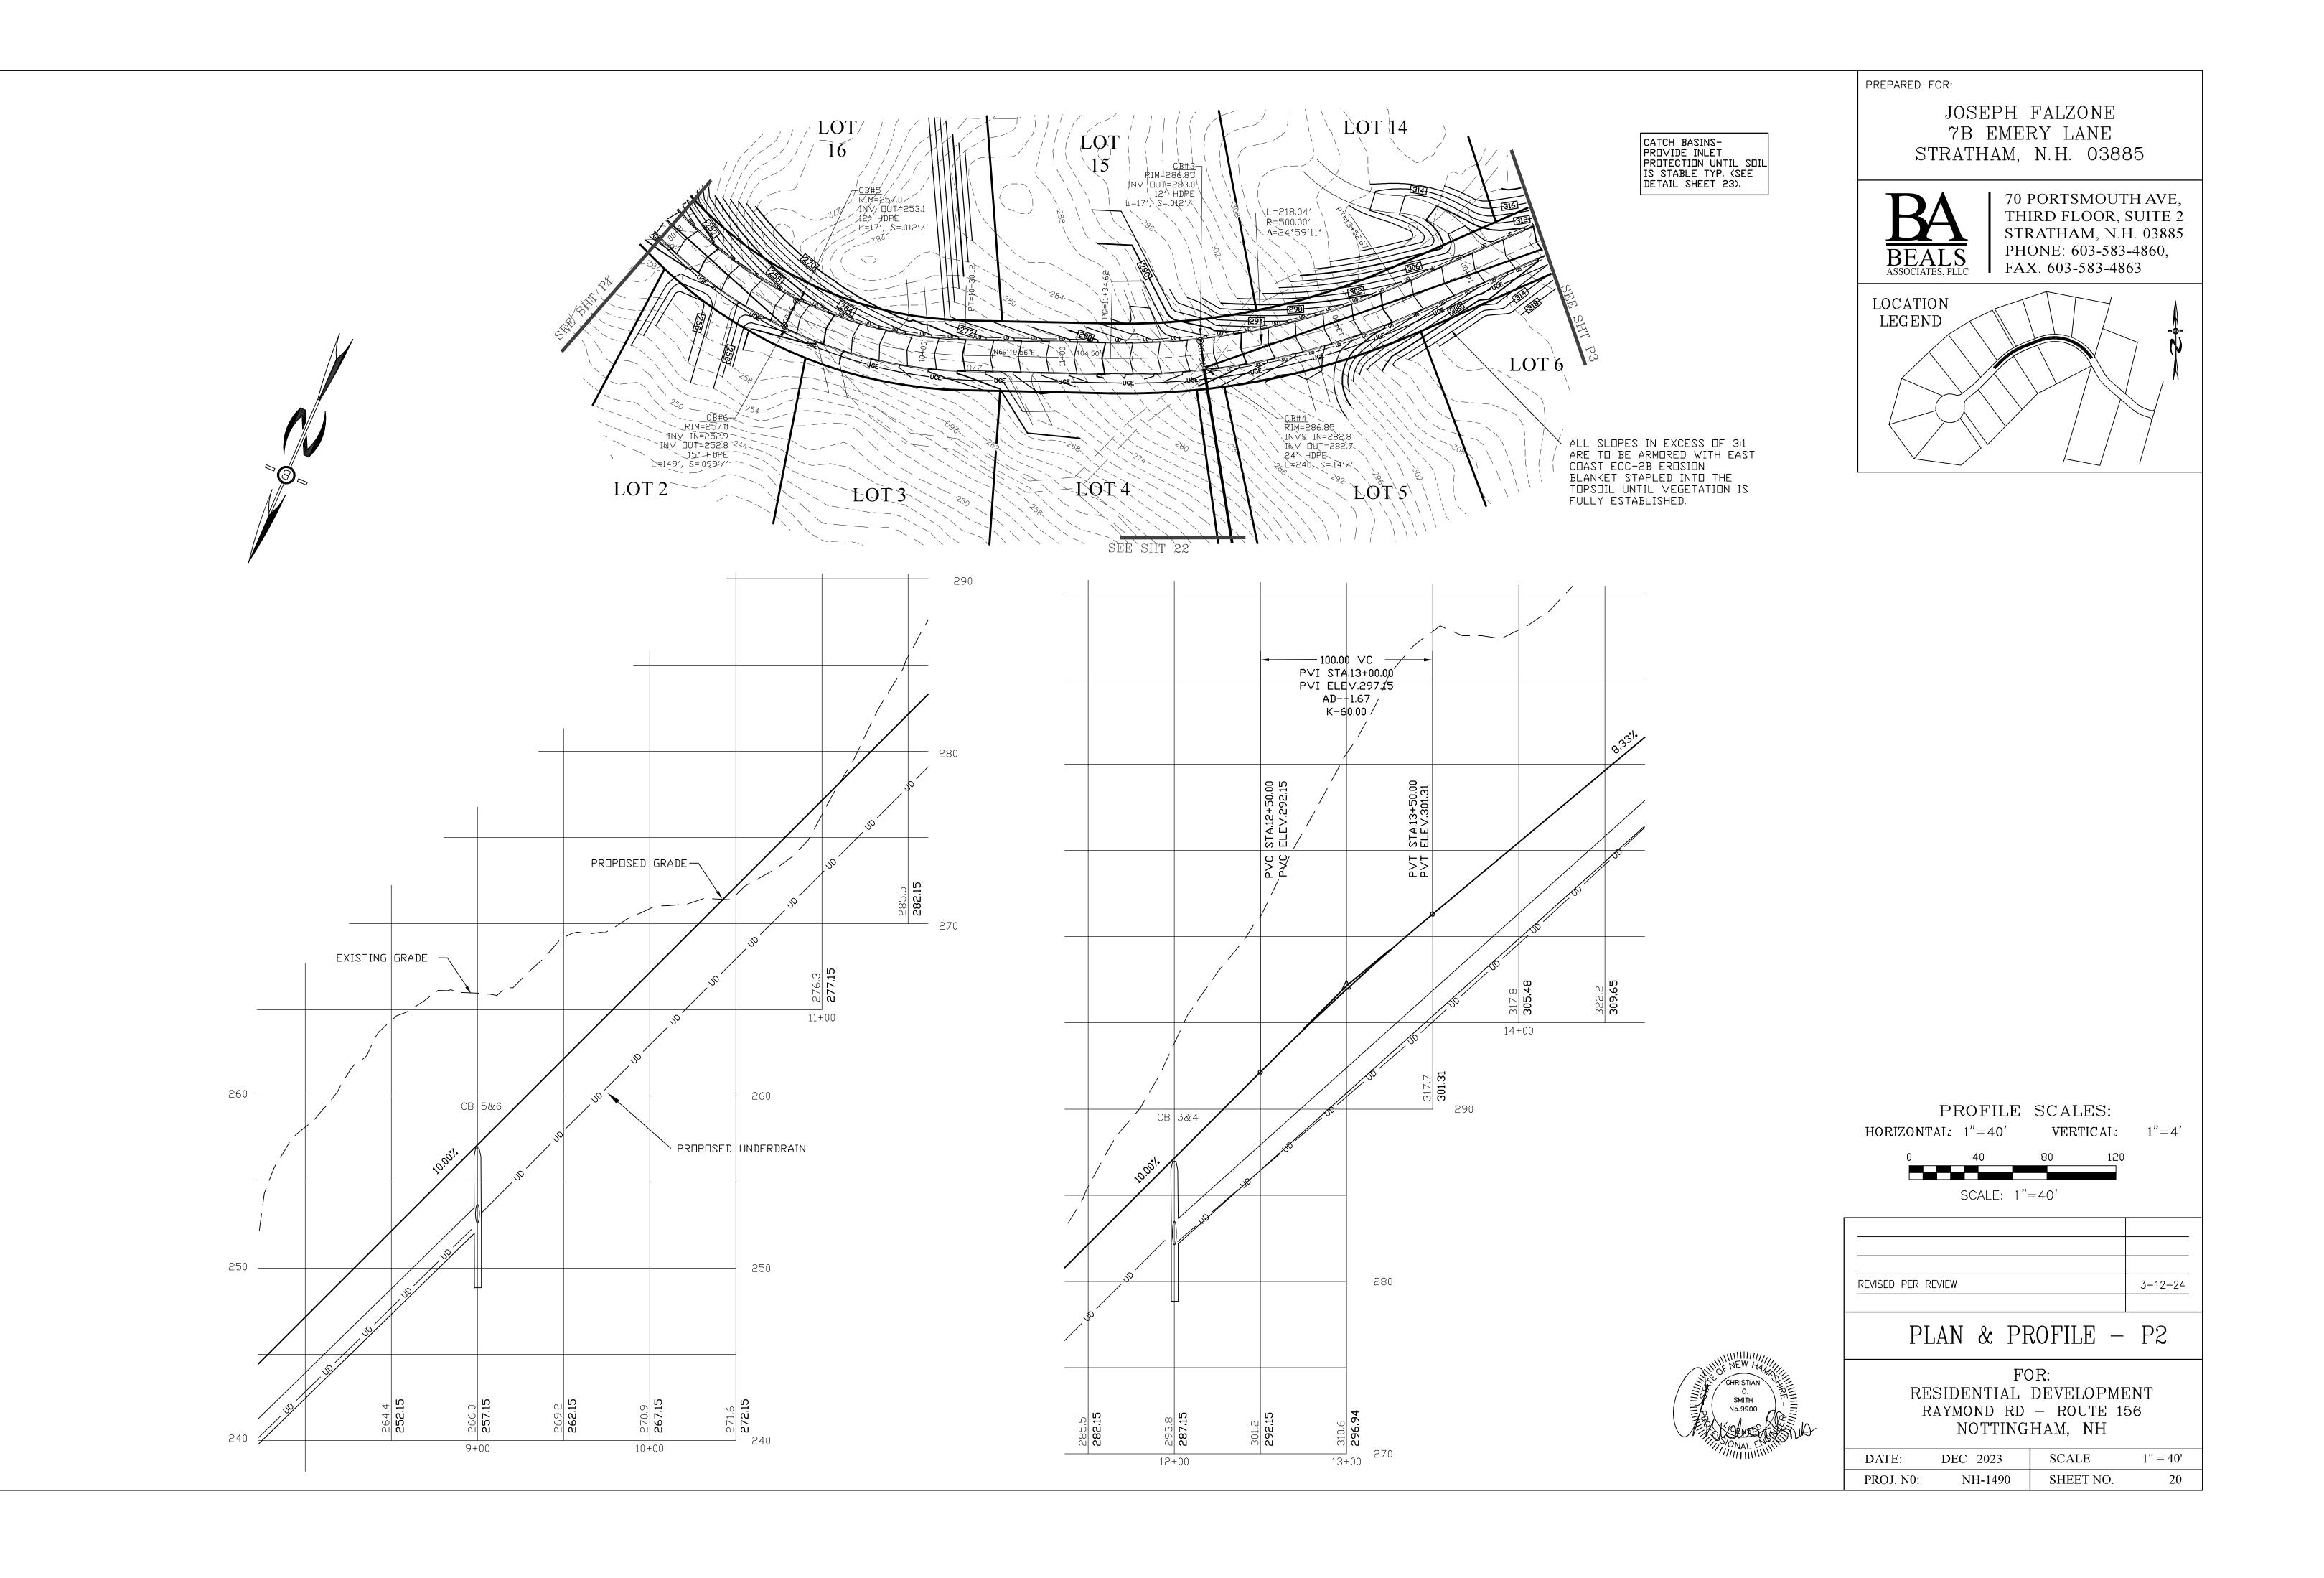
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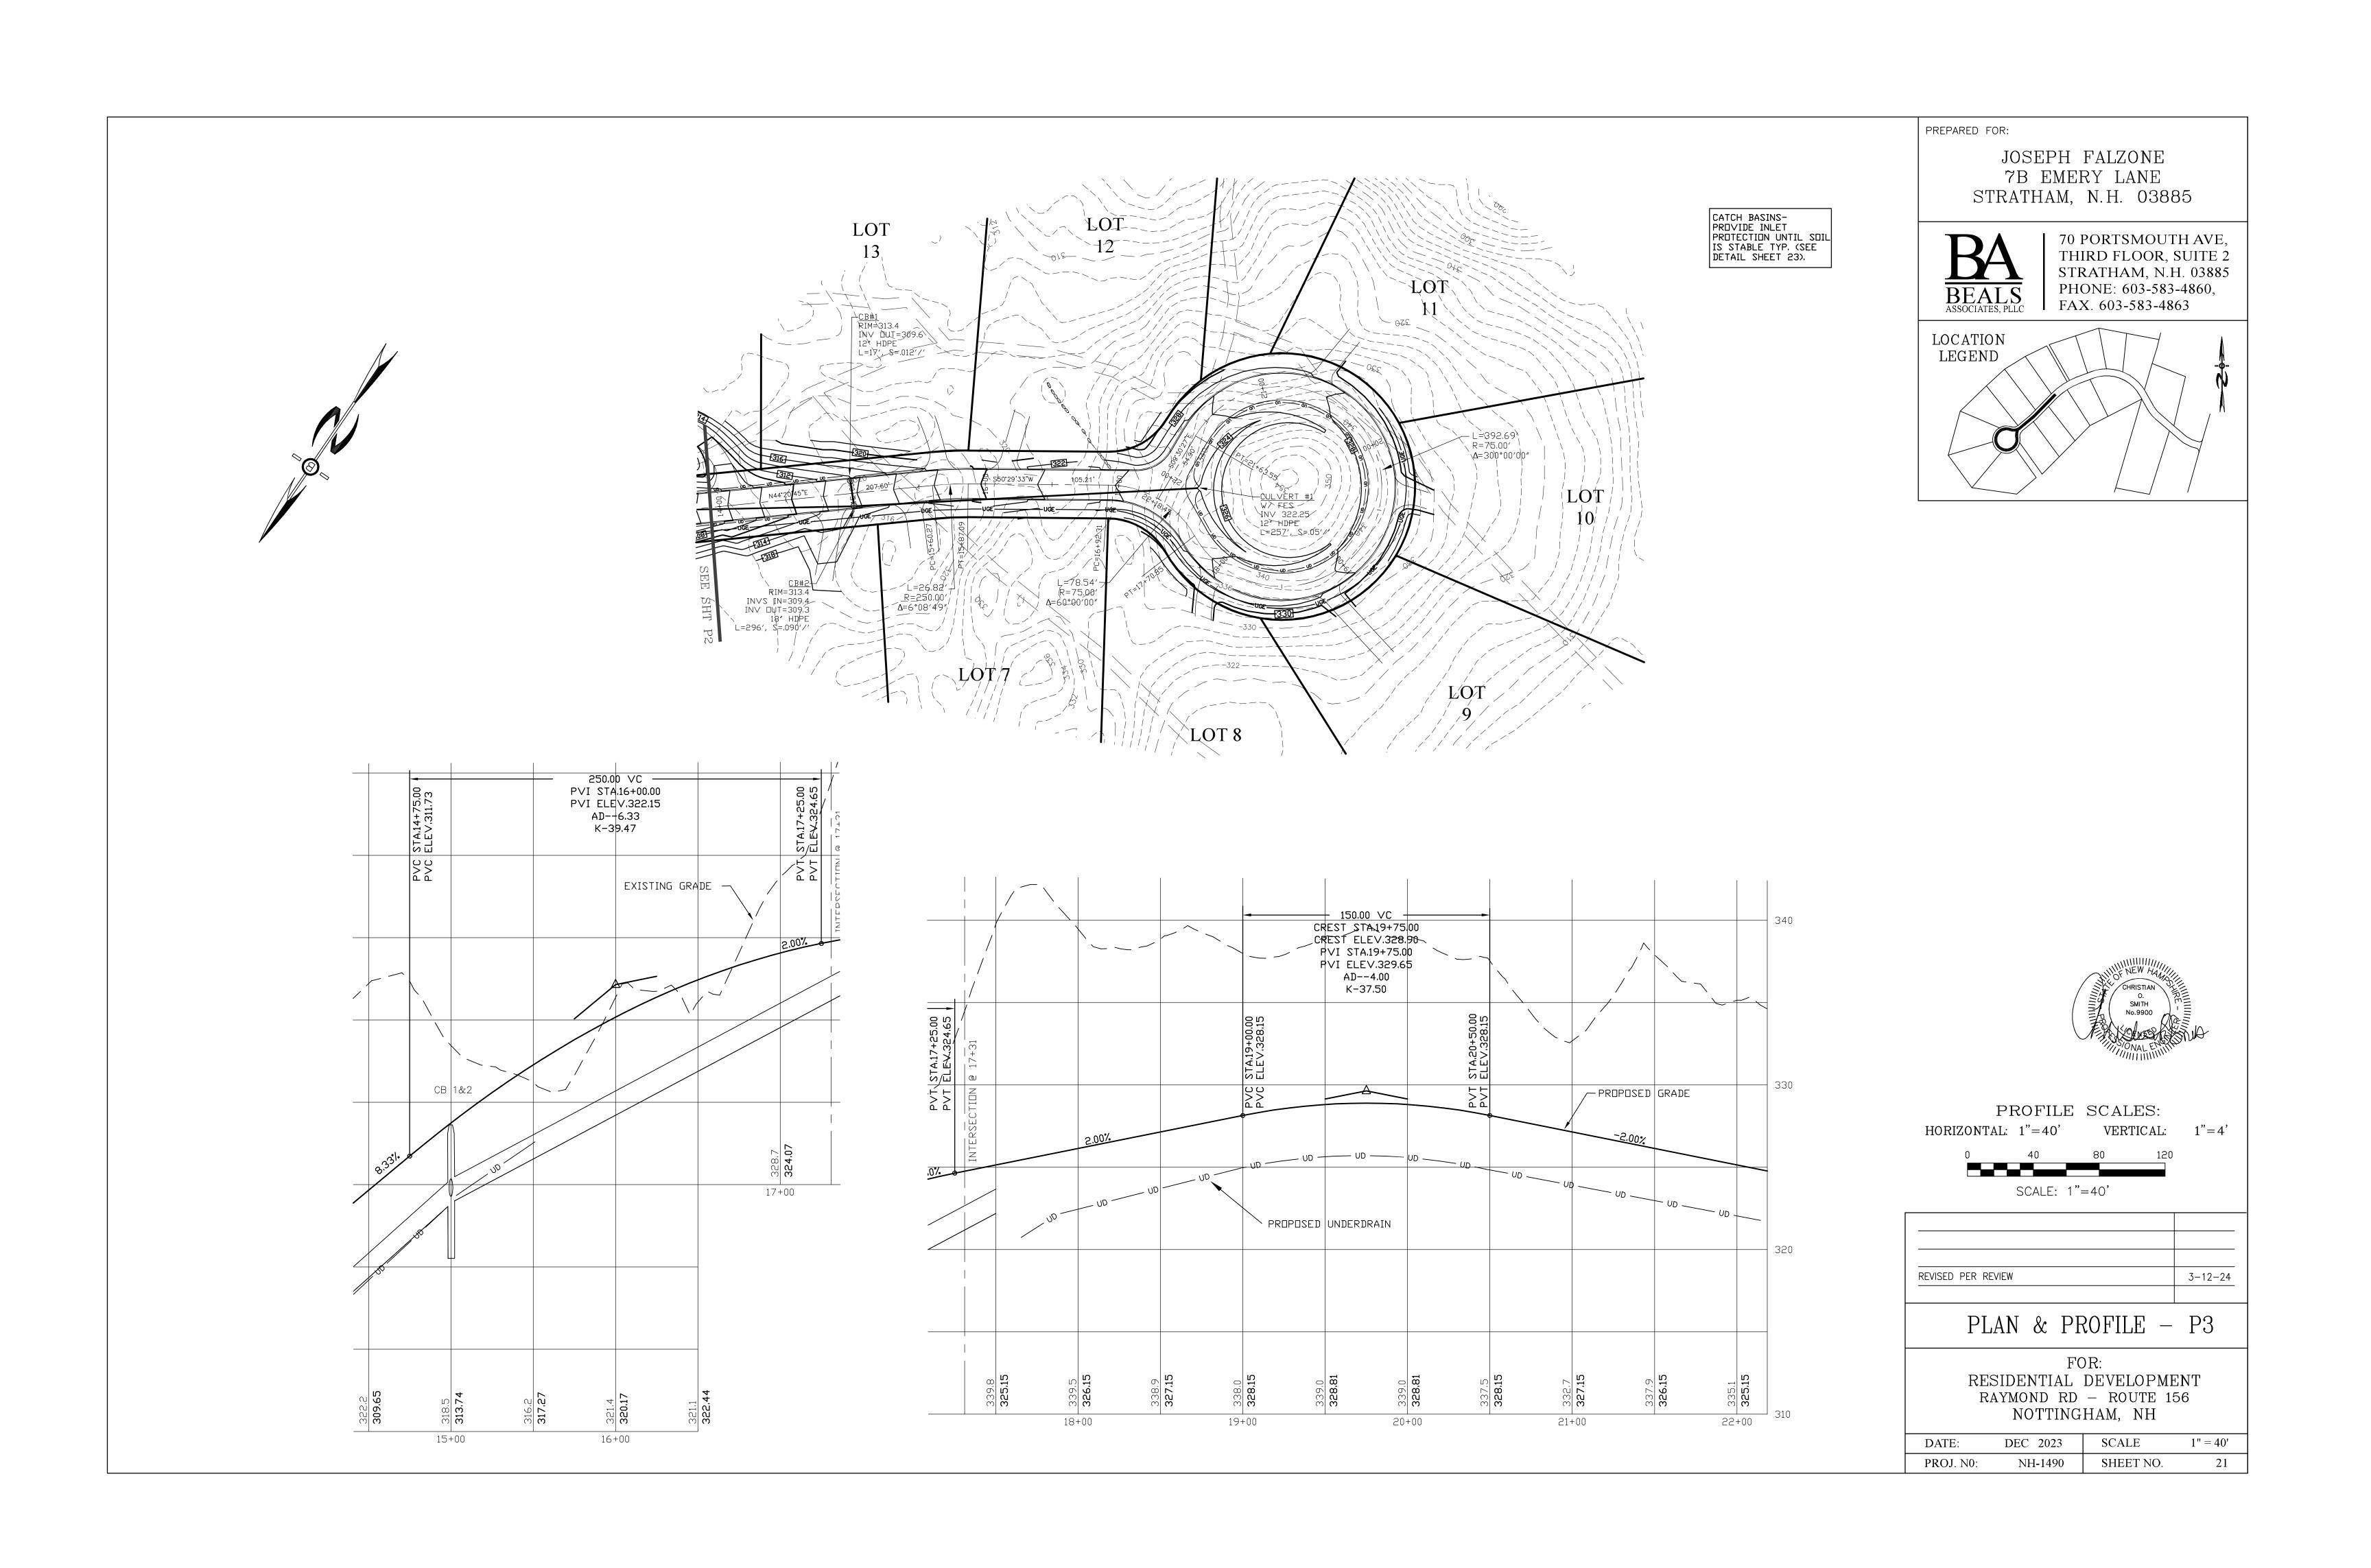
SIGN DETAIL


HIGHWAY ACCESS PLAN-H2

DATE:	DEC 2023	SCALE:	1"=20'
PROJ. N0:	NH-1490	SHEET NO.	18A







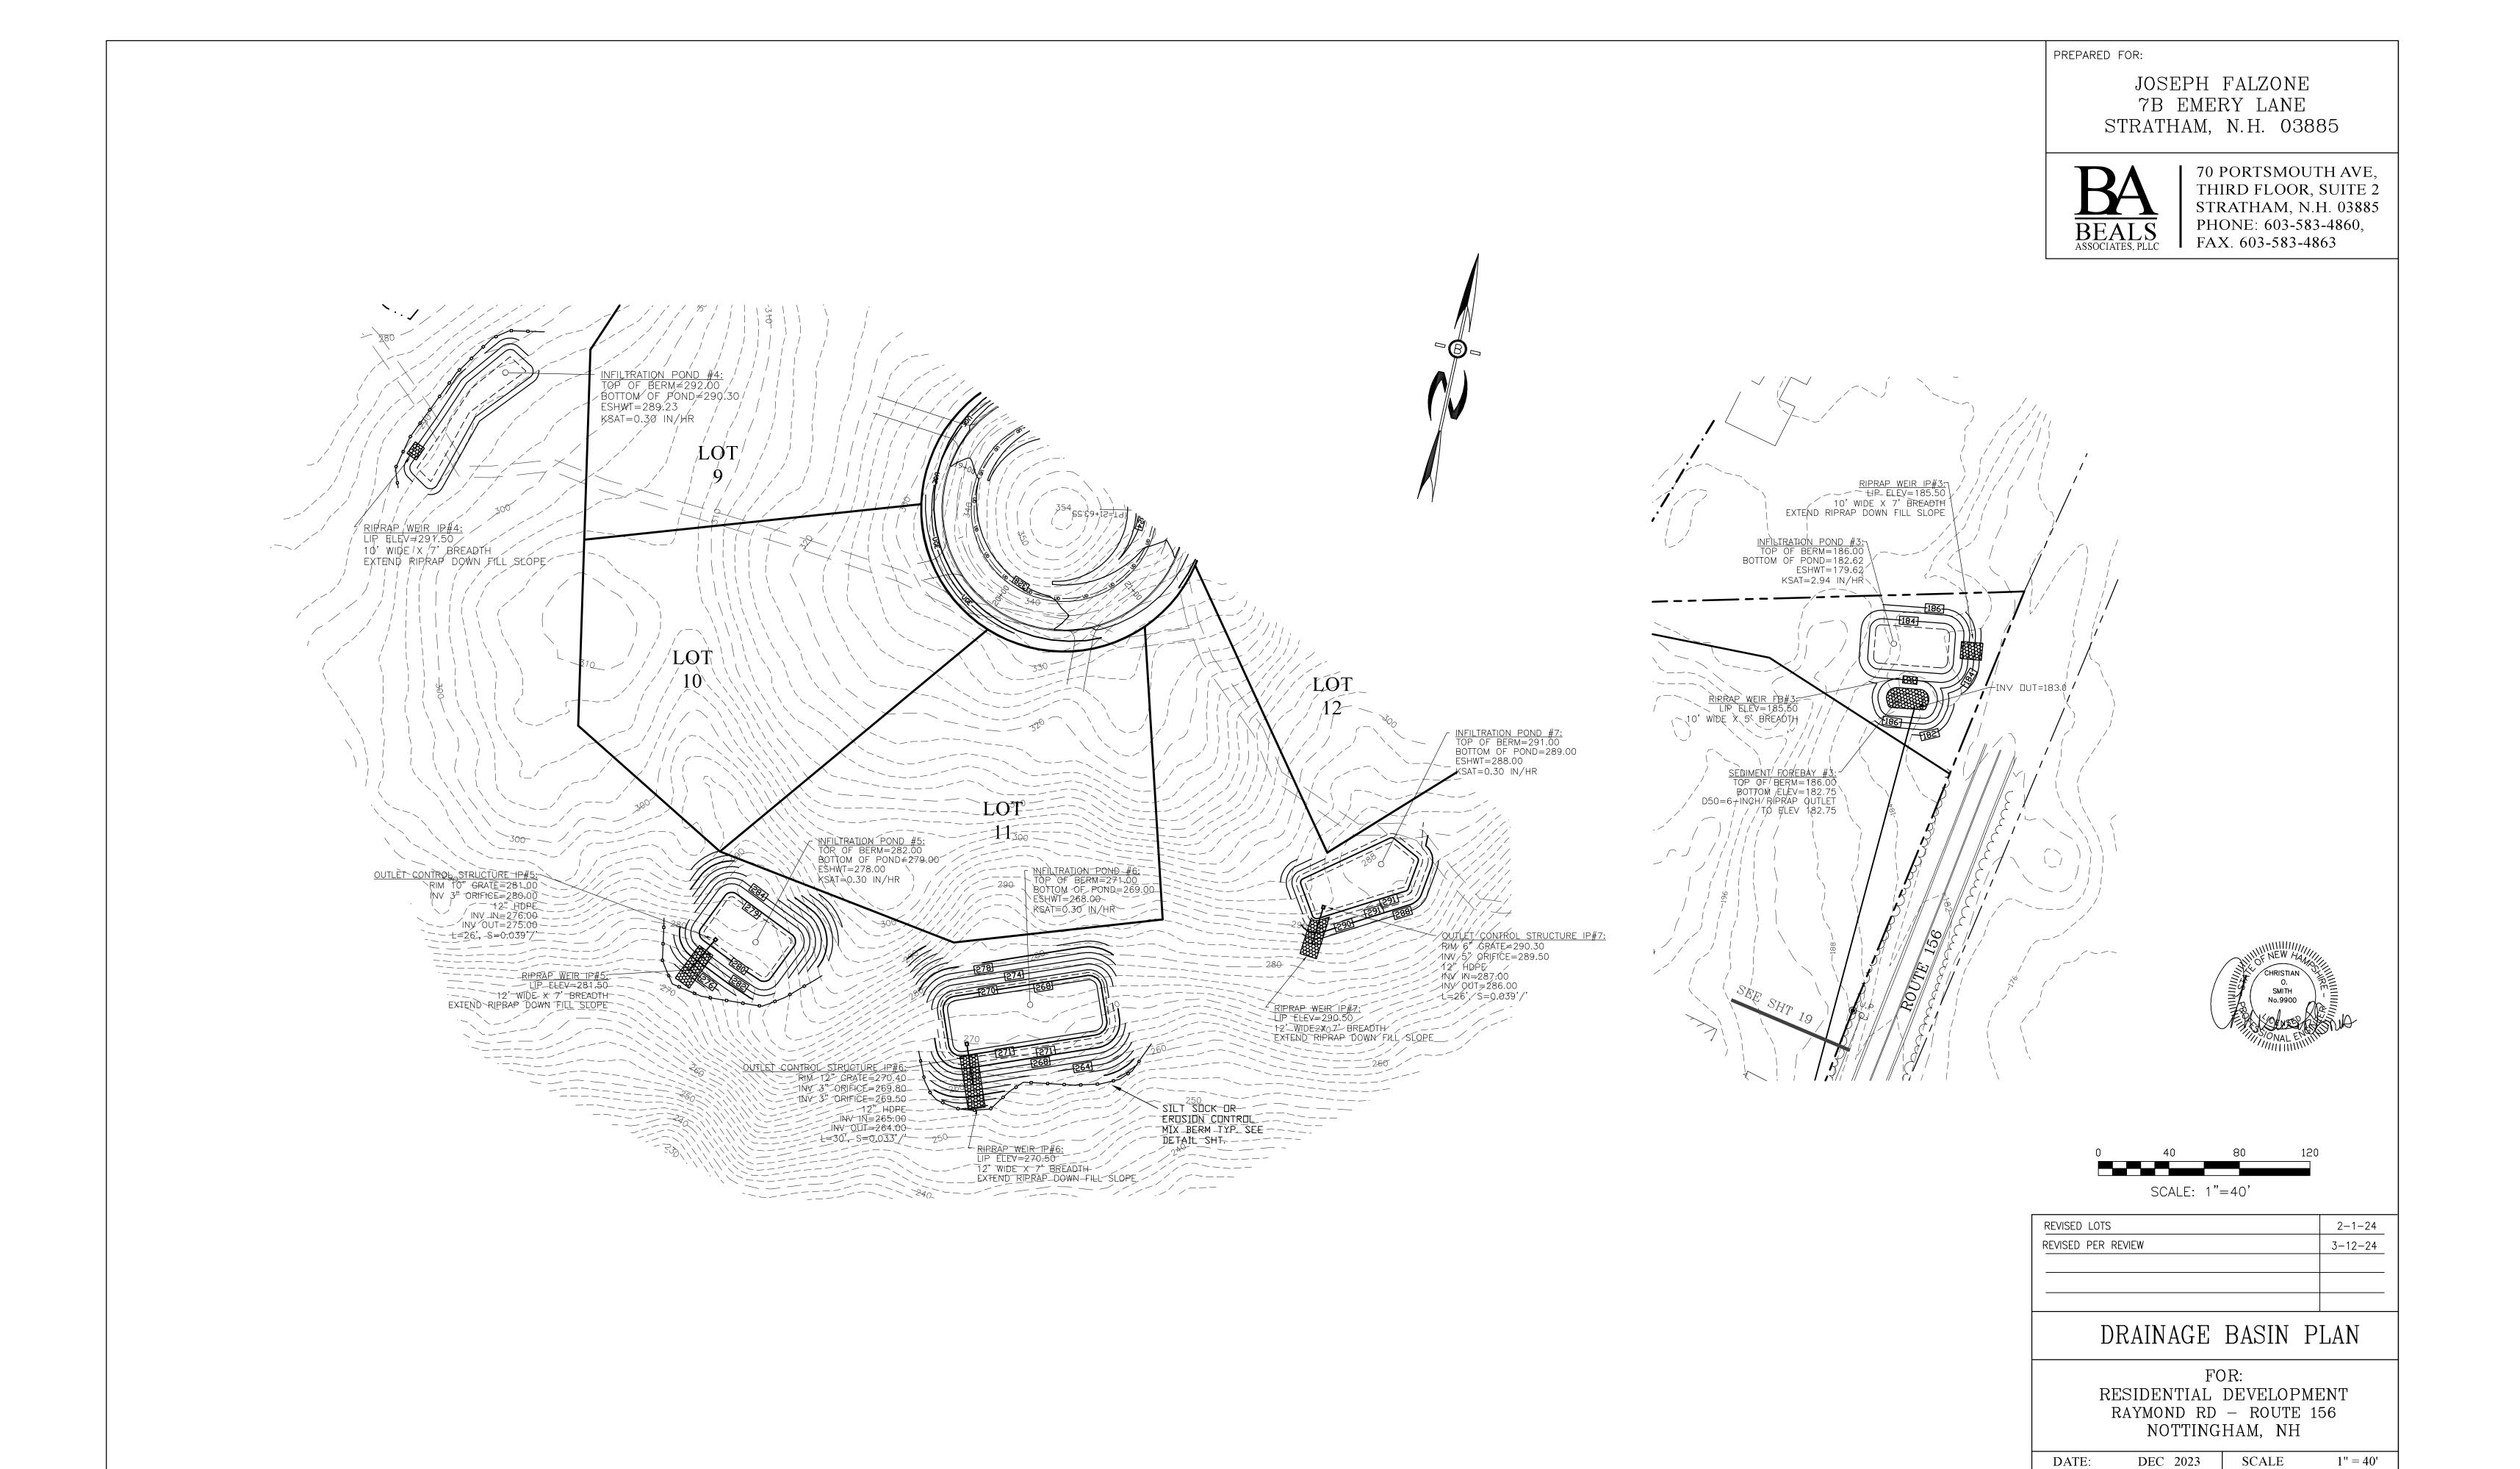



22

SHEET NO.

PROJ. N0:

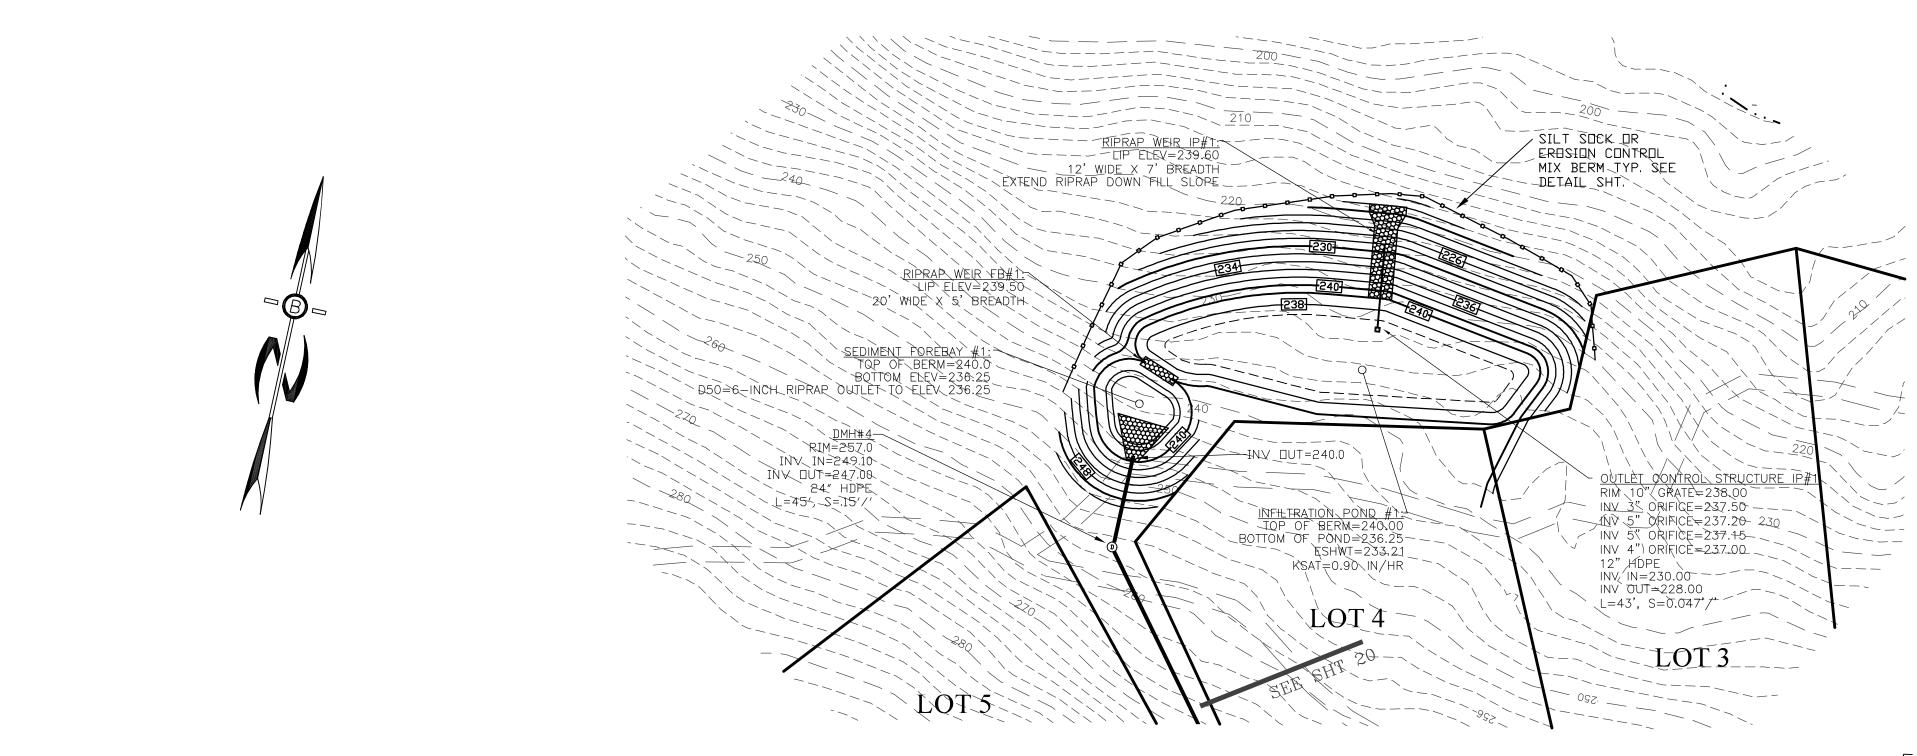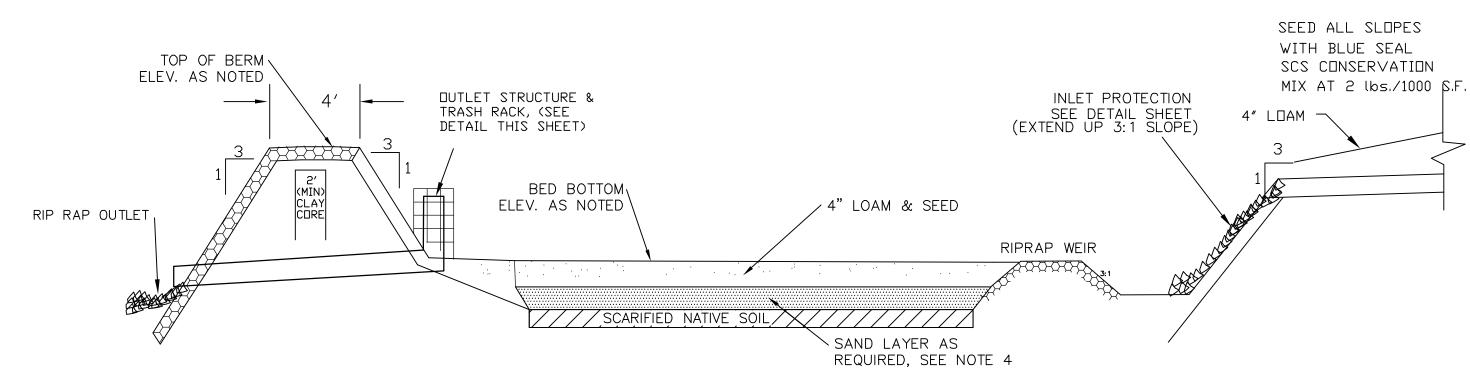NH-1490





CROSS SECTION OF INFILTRATION BASIN NOT TO SCALE

INFILTRATION BASIN NOTES:

- 1. DO NOT TRAFFIC EXPOSED SOIL SURFACE WITH CONSTRUCTION EQUIPMENT. IF FEASIBLE, PERFORM EXCAVATION WITH EQUIPMENT POSITIONED OUTSIDE THE LIMITS OF THE INFILTRATION SYSTEM.
- AFTER THE INFILTRATION SYSTEM AREA IS EXCAVATED TO THE FINAL DESIGN ELEVATION, THE FLOOR SHOULD BE DEEPLY TILLED WITH A ROTARY TILLER OR DISC HARROW TO RESTORE INFILTRATION RATES. FOLLOWED BY A PASS WITH A LEVELING DRAG.
 DO NOT PLACE INFILTRATION SYSTEM INTO SERVICE UNTIL THE CONTRIBUTING AREAS HAVE BEEN FULLY STABILIZED.
- 4. REMOVE LOAM AND ORGANICS FROM EXISTING SOILS. IF NECESSARY, REPLACE WITH MATERIAL MEETING ASTM C-33 SPECIFICATIONS TO REQUIRED ELEVATION BELOW BED BOTTOM LOAM AND SEED.

Construction Sequence

- 1. Protect Infiltration basin area from compaction prior to installation.
- 2. After installation, protect sediment—laden water from entering inlets and pipes.
- 3. Install and maintain proper Erosion and Sediment Control Measures during construction.
- 4. If necessary, excavate Infiltration basin bottom to an uncompacted subgrade free from rocks and debris. Do NOT compact subgrade.
- 5. Install Outlet Control Structures.
- 6. Seed and stabilize topsoil. (Vegetate if appropriate with native plantings.)
- 7. Do not remove Inlet Protection or other Erosion and Sediment Control measures until site is fully stabilized.
- 8. Any sediment that enters inlets during construction is to be removed within 24 hours.

<u>Maintenance</u> and Inspection

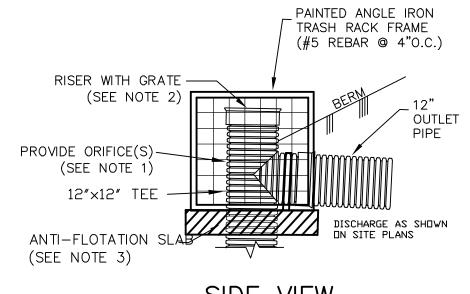
- Catch Basins and Inlets (upgradient of infiltration basin) should be inspected and cleaned on an annual basis.
- The vegetation along the surface of the Infiltration basin should be maintained in good condition, and any bare spots immediately revegetated.
- Vehicles should not be parked or driven on an Infiltration Basin, and care should be taken to avoid excessive compaction by mowers. • Inspect the completed basin and make sure that runoff drains down within 72 hours.
- Also inspect for accumulation of sediment, damage to outlet control structures, erosion control measures, signs of water contamination/spills,
- and slope stability in the berms. • Mosquito's should not be a problem if the water drains in 72 hours. Mosquitoes require a considerably long breeding period with relatively static
- Mow only as appropriate for vegetative cover species.
- Remove sediment from basin accumulations. Restore original cross section and infiltration rate. Properly dispose of sediment.

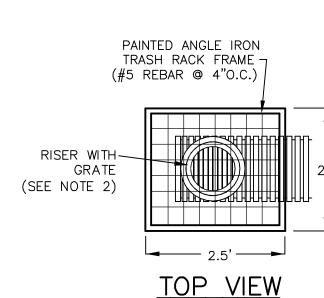
PREPARED FOR:

JOSEPH FALZONE 7B EMERY LANE STRATHAM, N.H. 03885



70 PORTSMOUTH AVE, THIRD FLOOR, SUITE 2 STRATHAM, N.H. 03885 PHONE: 603-583-4860, FAX. 603-583-4863





SIDE VIEW

INFILTRATION POND ORIFICE TABLE

POND #	ORIENTATION	SIZE (IN)	ELEVATION
1	0°	3"	237.50
1	90°	5"	237.20
1	180°	5"	237.15
1	270°	4"	237.00
2	0°	3"	269.80
2	180°	3"	269.50
5	0°	3"	280.00
6	0°	3"	269.50
6	180°	3"	269.80
7	0°	5"	289.50

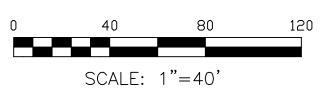


- NOTES:

 1. SEE INDIVIDUAL INFILTRATION POND DETAILS FOR ORIFICE ELEVATION AND DIAMETER. ORIFICES FOR INFILTRATION POND #1 SHALL BE LOCATED 90 DEGREES APART AND 180 DEGREES APART FOR INFILTRATION PONDS #2 AND #6. SEE TABLE ABOVE.

 2. SEE INDIVIDUAL INFILTRATION POND DETAILS FOR GRATE ELEVATION AND DIAMETER.
- 3. PROVIDE 3'X3'X6" CONCRETE ANTI-FLOTATION SLAB WITH NON-CORROSIVE HOLDING STRAPS AND GASKETED 12" DIA CENTERED RECEIVING HOLE FOR RISER EXTENSION INTO GRAVEL


OUTLET CONTROL STRUCTURE NOT TO SCALE



REVISED LOTS	2-1-24
REVISED PER REVIEW	3-12-24


DRAINAGE BASIN PLAN

DATE:	DEC 2023	SCALE	1" = 40'
PROJ. N0:	NH-1490	SHEET NO.	23

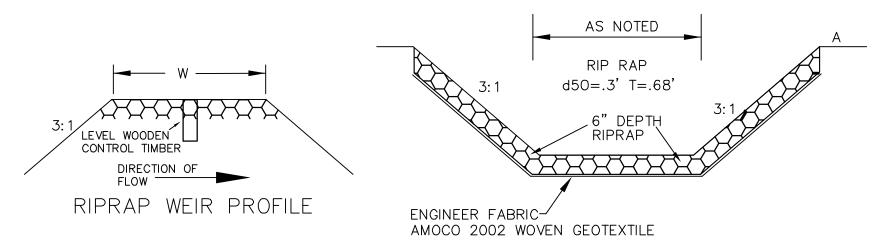

RIPRAP SPILLWAY DETAILS
WHERE SPECIFIED

Table 4-13. Gradation of Stone for Level Spreader Berm			
Sieve Designation Percent by Weight Passing Square Mesh Sieve			
12-inch	100%		
6-inch	84% - 100%		
3-inch	68% - 83%		
1-inch	42% - 55%		
No. 4	8% - 12%		

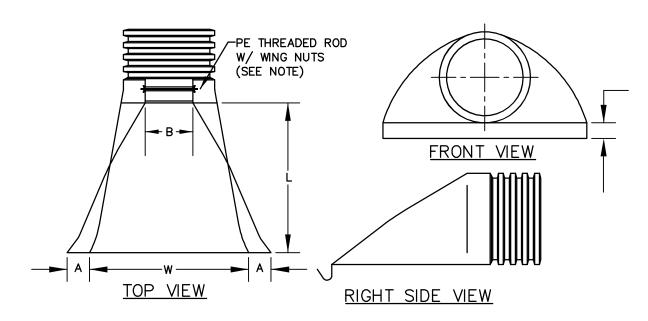


PART No.	PIPE SIZE	А	B(MAX)	Н	L	w
1510-NP	15" 375 mm	6.5" 165 mm	10" 254 mm	6.5" 165 mm	25" 635 mm	29" 735 mm
1810-NP	18" 450 mm	7.5" 190 mm	15" 380 mm	6.5" 165 mm	32" 812 mm	35" 890 mm
2410-NP	24" 600 mm	7.5" 190 mm	18" 450 mm	6.5" 165 mm	36" 900 mm	45" 1140 mm
3010-NP	30" 750 mm	10.5" 266 mm	N/A	7.0" 178 mm	53" 1345 mm	68" 1725 mm
3610-NP	36" 900 mm	10.5" 266 mm	N/A	7.0" 178 mm	53" 1345 mm	68" 1725 mm

NOTE: PE THREADED ROD W/ WING NUTS PROVIDED FOR END SECTIONS 15"-24".
30" & 36" END SECTIONS TO BE WELDED PER MANUFACTURER'S

ADS N-12 FLARED END SECTIONS

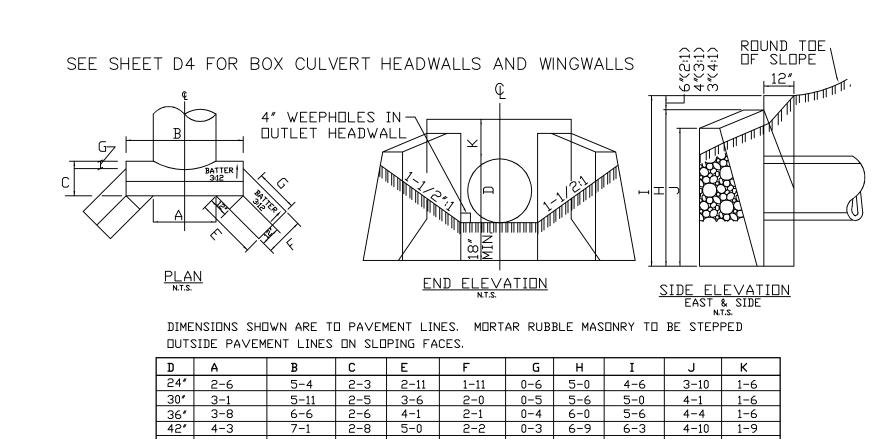
NOT TO SCALE (ALL DIMENSIONS ARE NOMINAL)



MORTAR RUBBLE, MASONRY HEADWALL W/ 45° WINGWALLS

NOT TO SCALE

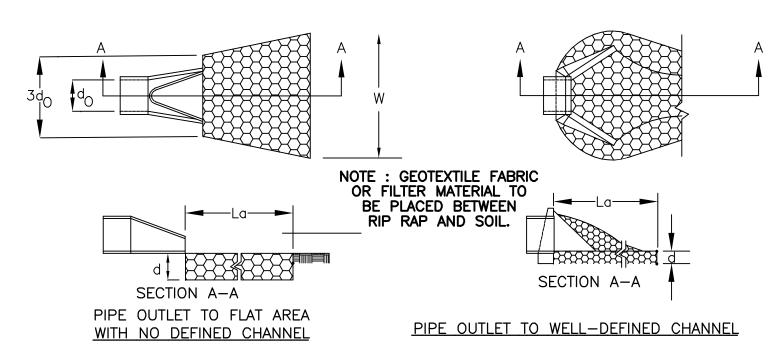48" 4-10 7-8 2-10 5-8 2-3 0-2 7-3 6-9 5-1 1-9



CONSTRUCTION SPECIFICATIONS

1. THE SUB GRADE FOR THE FILTER MATERIAL, GEOTEXTILE FABRIC, AND RIP RAP SHALL BE PREPARED TO THE LINES AND GRADES SHOWN ON THE PLANS.

2. THE ROCK OR GRAVEL USED FOR FILTER OF RIP RAP SHALL CONFORM TO THE SPECIFIED GRADATION. 3. GEOTEXTILE FABRICS SHALL BE PROTECTED FROM PUNCTURE OR TEARING DURING THE PLACEMENT OF THE ROCK RIP RAP. DAMAGED AREAS IN THE FABRIC SHALL BE REPAIRED BY PLACING A PIECE OF FABRIC OVER THE DAMAGED AREA OR BY COMPLETE REPLACEMENT OF THE FABRIC. ALL OVERLAPS REQUIRED FOR REPAIRS OR JOINING TWO PIECES OF FABRIC SHALL BE A MINIMUM OF 12

4. STONE FOR THE RIP RAP MAY BE PLACED BY EQUIPMENT AND SHALL BE CONSTRUCTED TO THE FULL LAYER THICKNESS IN ONE OPERATION AND IN SUCH A MANNER AS TO PREVENT

SEGREGATION OF THE STONE SIZES.

5. STONE FOR RIRAP SHALL BE ANGULAR OR SUBANGULAR. THE STONES SHOULD BE SHAPED SO THAT THE LEAST DIMENSION OF THE STONE FRAGMENT SHALL BE NOT LESS THAN ONE—THIRD OF THE GREATEST DIMENSION OF THE FRAGMENT.

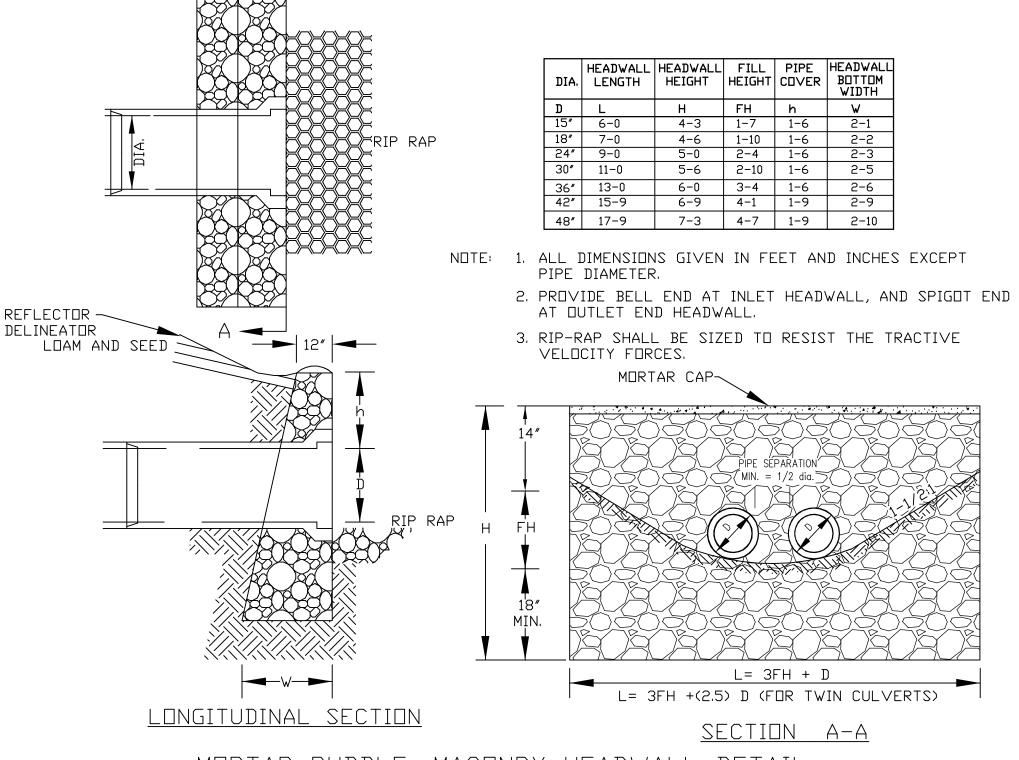
6. FLAT ROCKS SHALL NOT USED FOR RIP RAP. VOIDS IN THE ROCK RIPRAP SHOULD BE FILLED WITH SPALLS AND SMALLER ROCKS.

MAINTENANCE

1. THE OUTLET PROTECTION SHOULD BE CHECKED AT LEAST ANNUALLY AND AFTER EVERY MAJOR STORM. IF THE RIP RAP HAS BEEN DISPLACED, UNDERMINED OR DAMAGED, IT SHOULD BE REPAIRED IMMEDIATELY. THE CHANNEL IMMEDIATELY BELOW THE OUTLET SHOULD BE CHECKED TO SEE THAT EROSION IS NOT OCCURRING. THE DOWNSTREAM CHANNEL SHOULD BE KEPT CLEAR OF OBSTRUCTIONS SUCH AS FALLEN TREES, DEBRIS, AND SEDIMENT THAT COULD CHANGE FLOW PATTERNS AND/OR TAILWATER DEPTHS ON THE PIPES. REPAIRS MUST BE CARRIED OUT IMMEDIATELY TO AVOID ADDITIONAL


PIPE DUTLET PROTECTION


DAMAGE TO OUTLET PROTECTION.



MORTAR RUBBLE, MASONRY HEADWALL DETAIL

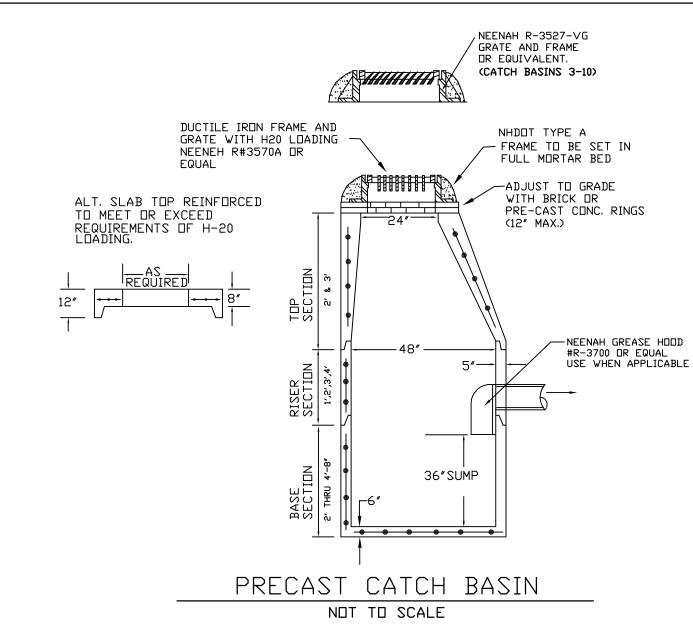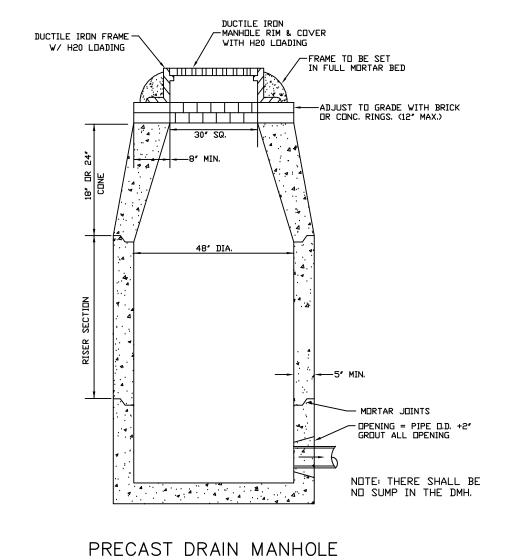
NOT TO SCALE





TYDICAL DDAINIACE TDENICH DETAIL

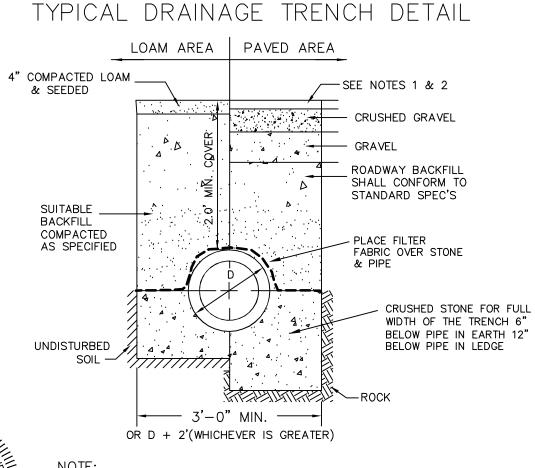NOT TO SCALE



OTE:

1. PAVEMENT REPAIR IN EXISTING ROADWAYS SHALL
CONFORM TO STREET OPENING REGULATIONS.

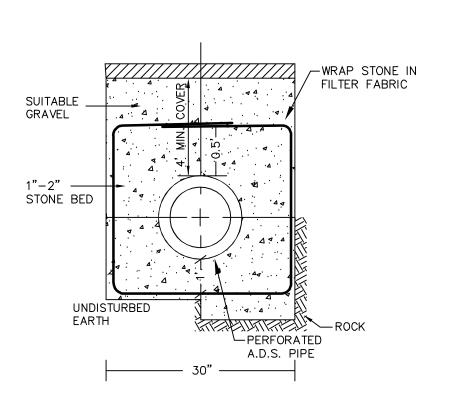
2. NEW ROADWAY CONSTRUCTION SHALL CONFORM TO
SUBDIVISION SPEC'S.

PREPARED FOR:

JOSEPH FALZONE
7B EMERY LANE
STRATHAM, N.H. 03885




70 PORTSMOUTH AVE, THIRD FLOOR, SUITE 2 STRATHAM, N.H. 03885 PHONE: 603-583-4860, FAX. 603-583-4863



UNDERDRAIN TRENCH DETAIL

NOT TO SCALE

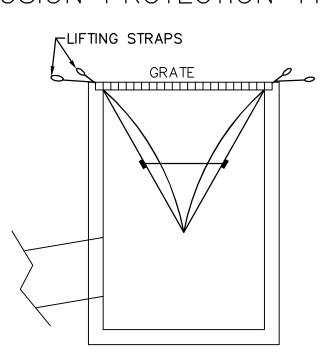EROSION PROTECTION TYPE E



SILTSACK DETAIL
NOT TO SCALE

RECOMMENDED MAINTENANCE

SCHEDULE

-EACH SITLSACK SHOULD BE INSPECTED

AFTER EVERY MAJOR RAIN EVENT

-IF THERE HAVE BEEN NO MAJOR EVENTS, SILTSACK SHOULD BE INSPECTED EVERY


-THE RESTRAINT CORD SHOULD BE VISIBLE AT ALL TIMES. IF CORD IS COVERED WITH SEDIMENT, THE SILTSACK SHOULD BE


EMPTIED.

REVISED PER REVIEW	3-12-24
REVISIONS:	DATE:

CONSTRUCTION DETAILS D1

DATE:	DEC 2023	SCALE:	N/A
PROJ. N0:	NH-1490	SHEET NO.	24

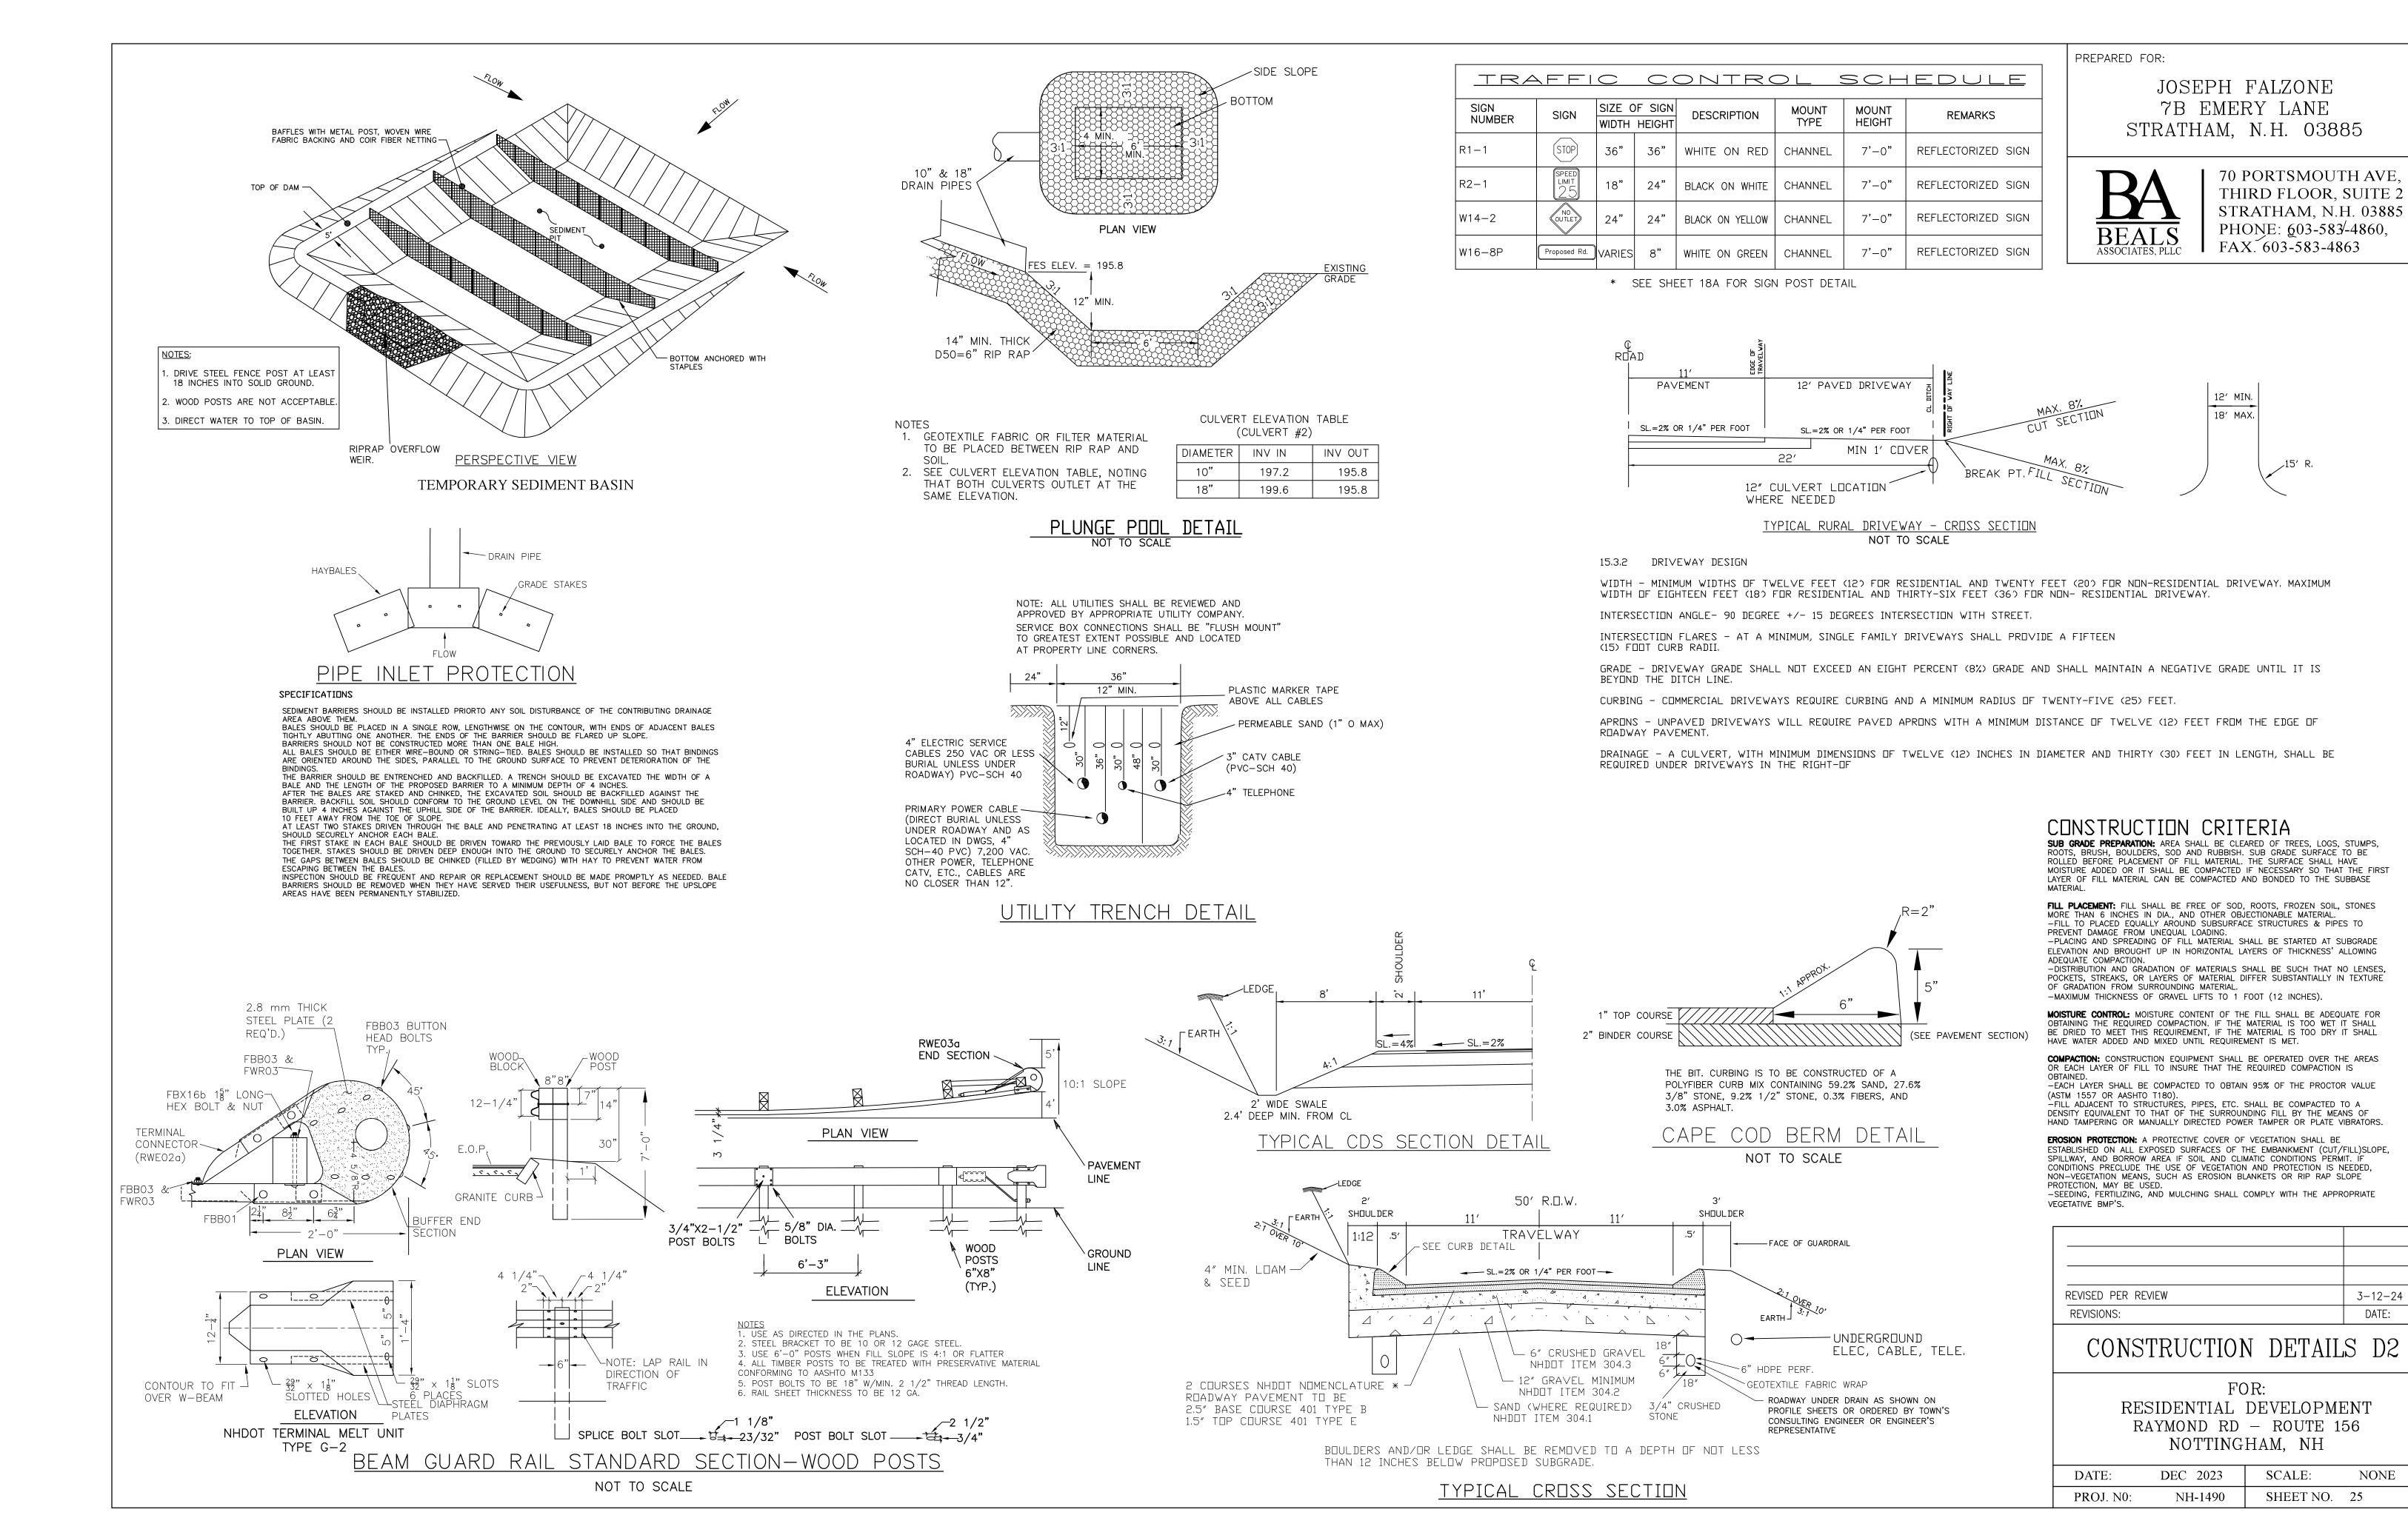

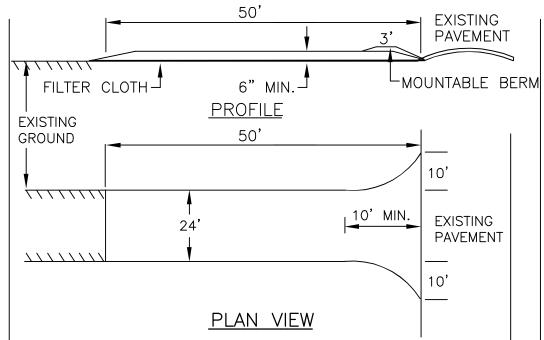

- 1. STONE FOR A STABILIZED CONSTRUCTION ENTRANCE SHALL BE 3 INCH STONE, RECLAIMED STONE, OR RECYCLED CONCRETE EQUIVALENT.
- 2. THE LENGTH OF THE STABILIZED ENTRANCE SHALL NOT BE LESS THAN 75 FEET UNLESS A MOUNTABLE BERM IS PROVIDED. EXCEPT FOR A SINGLE RESIDENTIAL LOT WHERE A 30 FOOT MINIMUM LENGTH WOULD
- 3. THE THICKNESS OF THE STONE FOR THE STABILIZED ENTRANCE SHALL NOT BE LESS THAN 6 INCHES. 4. THE WIDTH OF THE ENTRANCE SHALL NOT BE LESS THAN THE FULL WIDTH OF THE ENTRANCE WHERE INGRESS OR EGRESS OCCURS OR 10 FEET, WHICH EVER IS GREATER. 5. GEOTEXTILE FILTER CLOTH SHALL BE PLACED OVER THE ENTIRE AREA PRIOR TO PLACING THE STONE. FILTER CLOTH IS NOT REQUIRED FOR A SINGLE FAMILY RESIDENCE LOT
- 6. ALL SURFACE WATER THAT IS FLOWING TO OR DIVERTED TOWARD THE CONSTRUCTION ENTRANCE SHALL BE PIPED BENEATH THE ENTRANCE. IF PIPING IS IMPRACTICAL, A BERM WITH 5:1 SLOPES THAT CAN BE CROSSED BY VEHICLES MAY BE SUBSTITUTED FOR THE PIPE
- 7. THE ENTRANCE SHALL BE MAINTAINED IN A CONDITION THAT WILL PREVENT TRACKING OR FLOWING OF SEDIMENT ONTO PUBLIC RIGHTS-OF-WAY. THIS MAY REQUIRE PERIODIC TOP DRESSING WITH ADDITIONAL STONE AS CONDITIONS DEMAND AND REPAIR AND/OR CLEAN OUT OF ANY MEASURES USED TO TRAP SEDIMENT. ALL SEDIMENT SPILLED, WASHED, OR TRACKED ONTO PUBLIC RIGHT-OF-WAY MUST BE REMOVED PROMPTLY.
 - STABILIZED CONSTRUCTION ENTRANCE

TEMPORARY EROSION CONTROL MEASURES

1. THE SMALLEST PRACTICAL AREA SHALL BE DISTURBED DURING CONSTRUCTION, BUT NO MORE THAN 5 ACRES OF LAND SHALL BE EXPOSED BEFORE DISTURBED AREAS ARE STABILIZED*.

2. EROSION, SEDIMENT AND DETENTION MEASURES SHALL BE INSTALLED AS SHOWN ON THE PLANS AND AT LOCATIONS AS REQUIRED OR DIRECTED BY THE ENGINEER ALL DISTURBED AREAS SHALL BE RETURNED TO ORIGINAL GRADES AND ELEVATIONS. 3. DISTURBED AREAS SHALL BE LOAMED WITH A MINIMUM OF 4" OF LOAM AND SEEDED WITH NOT LESS THAN 1.10 POUNDS OF SEED

PER 1000 SQUARE FEET OF AREA. (48 POUNDS PER ACRE) SEE SEED SPECIFICATIONS THIS SHEET. 4. SILT FENCES AND OTHER EROSION CONTROLS SHALL BE INSPECTED WEEKLY AND AFTER EVERY RAIN EVENT GREATER THAN 0.5" DURING THE LIFE OF THE PROJECT. ALL DAMAGED AREAS SHALL BE REPAIRED, SEDIMENT DEPOSITS SHALL PERIODICALLY BE REMOVED AND DISPOSED OF.

5. AFTER ALL DISTURBED AREAS HAVE BEEN STABILIZED, THE TEMPORARY EROSION CONTROL MEASURES ARE TO BE REMOVED AND THE AREA DISTURBED BY THE REMOVAL SMOOTHED AND RE-VEGETATED. 6. AREAS MUST BE SEEDED AND MULCHED WITHIN 3 DAYS OF FINAL GRADING, PERMANENTLY STABILIZED WITHIN 15 DAYS OF FINAL

GRADING, OR TEMPORARILY STABILIZED WITHIN 30 DAYS OF INITIAL DISTURBANCE OF SOIL. * AN AREA SHALL BE CONSIDERED STABLE IF ONE OF THE FOLLOWING HAS OCCURRED:

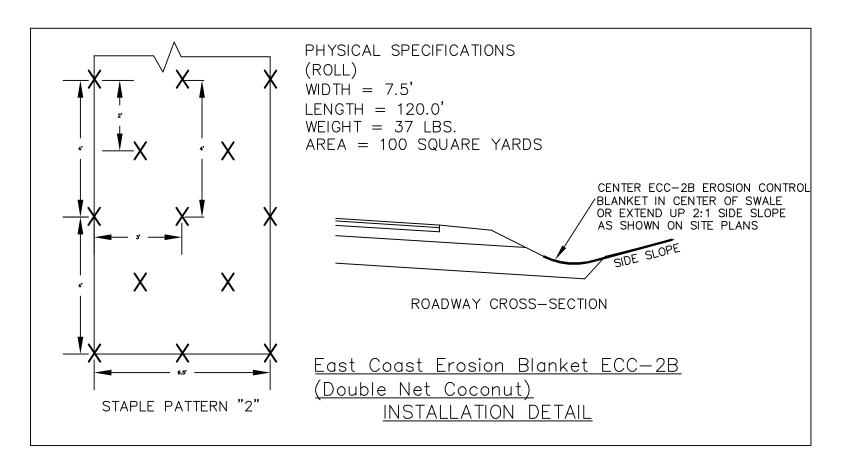
- BASE COURSE GRAVELS HAVE BEEN INSTALLED IN AREAS TO BE PAVED.
- A MINIMUM OF 85% VEGETATED GROWTH HAS BEEN ESTABLISHED. - A MINIMUM OF 3 INCHES OF NON-EROSIVE MATERIAL SUCH AS RIPRAP HAS BEEN INSTALLED.
- EROSION CONTROL BLANKETS HAVE BEEN PROPERLY INSTALLED.

CONSTRUCTION SPECIFICATIONS

- 1. STRUCTURES SHALL BE INSTALLED ACCORDING TO THE DIMENSIONS SHOWN ON THE PLANS AT THE
- APPROPRIATE SPACING. 2. CONSTRUCTION OPERATIONS SHALL BE CARRIED OUT IN SUCH A MANNER SO THAT EROSION AND AIR AND WATER POLLUTION WILL BE MINIMIZED.
- 3. WHEN TIMBER STRUCTURES ARE USED, THE TIMBER SHALL EXTEND AT LEAST 18" INTO THE SOIL. 4. STRAW BALES SHALL BE ANCHORED INTO THE SOIL USING 2" X 2" STAKES DRIVEN THROUGH THE BALES
- AND AT LEAST 18 INCHES IN TO THE SOIL. 5. SEEDING, FERTILIZING, AND MULCHING SHALL CONFORM TO THE RECOMMENDATIONS IN THE APPROPRIATED
- VEGETATIVE BMP. 6. STRUCTURES SHALL BE REMOVED FROM THE CHANNEL WHEN THEIR USEFUL LIFE HAS BEEN COMPLETED. 7. THROUGHOUT THE DURATION OF CONSTRUCTION ACTIVITIES THE CONTRACTOR SHALL TAKE PRECAUTIONS
- AND INSTRUCTIONS FROM THE PLANNING DEPARTMENT IN ORDER TO PREVENT, ABATE AND CONTROL THE EMISSION OF FUGITIVE DUST INCLUDING BUT NOT LIMITED TO WETTING, COVERING, SHIELDING, OR VACUUMING. 8. THE NH COMMISSIONER OF AGRICULTURE PROHIBITS THE COLLECTION, POSSESSION, IMPORTATION, TRANSPORTATION, SALE, PROPAGATION, TRANSPLANTATION, OR CULTIVATION OF PLANTS BANNED BY NH
- LAW RSA 430:53 AND NH CODE ADMINISTRATIVE RULES AGR 3800. THE PROJECT SHALL MEET ALL REQUIREMENTS AND THE INTENT OF . RSA 430:53 AND AGR 3800 RELATIVE TO INVASIVE SPECIES 9. IN THE EVENT THAT GREATER THAN ONE ACRE OF CONTIGUOUS DISTURBANCE OCCURS, THE CONSTRUCTION SITE OPERATOR AND OWNER SHALL SUBMIT A NOTICE OF INTENT (NOI) TO USEPA,
- WASHINGTON, DC, STORMWATER NOTICE PROCESSING CENTER AT LEAST FOURTEEN DAYS PRIOR TO COMMENCEMENT OF WORK ON SITE. EPA WILL POST THE NOI AT
- http://cfpubl.epa.gov/npdes/stormwater/noi/noisearch.cfm. AUTHORIZATION IS GRANTED UNDER THE PERMIT ONCE THE NOI IS SHOWN IN "ACTIVE STATUS".

CONSTRUCTION SEQUENCE

- 1. CUT AND REMOVE TREES IN CONSTRUCTION AREAS AS REQUIRED OR DIRECTED.
- 2. CONSTRUCT AND/OR INSTALL TEMPORARY AND PERMANENT SEDIMENT EROSION AND DETENTION CONTROL FACILITIES AS REQUIRED. EROSION, SEDIMENT AND DETENTION CONTROL FACILITIES SHALL BE INSTALLED AND STABILIZED PRIOR TO ANY EARTH MOVING OPERATION AND PRIOR TO DIRECTING RUNOFF TO THEM. 3. CLEAR, CUT, GRUB AND DISPOSE OF DEBRIS IN APPROVED FACILITIES. STUMPS AND DEBRIS ARE TO BE REMOVED
- FROM SITE AND DISPOSED OF PER STATE AND LOCAL REGULATIONS.
- 4. EXCAVATE AND STOCKPILE TOPSOIL /LOAM. ALL AREAS SHALL BE STABILIZED IMMEDIATELY AFTER GRADING. 5. CONSTRUCT TEMPORARY CULVERTS AS REQUIRED OR DIRECTED.
- 6. CONSTRUCT THE ROADWAY AND ITS ASSOCIATED DRAINAGE STRUCTURES. ALL ROADWAYS, AND CUT/FILL SLOPES SHALL BE STABILIZED AND/OR LOAMED AND SEEDED WITHIN 72-HOURS OF ACHIEVING FINISH GRADE AS APPLICABLE. 7. INSTALL PIPE AND CONSTRUCTION ASSOCIATED APPURTENANCES AS REQUIRED OR DIRECTED. ALL DISTURBED AREAS SHALL STABILIZED IMMEDIATELY AFTER GRADING.
- 8. BEGIN PERMANENT AND TEMPORARY SEEDING AND MULCHING. ALL CUT AND FILL SLOPES AND DISTURBED AREAS SHALL BE SEEDED OR MULCHED AS REQUIRED, OR DIRECTED.
- 9. DAILY OR AS REQUIRED, CONSTRUCT TEMPORARY BERMS, DRAINAGE CHECK DAMS, DITCHES, SEDIMENT TRAPS, ETC. TO PREVENT EROSION ON THE SITE AND PREVENT ANY SILTATION OF ABUTTING WATERS OR PROPERTY. 10. INSPECT AND MAINTAIN ALL EROSION AND SEDIMENT CONTROL MEASURES DURING CONSTRUCTION
- 11. COMPLETE PERMANENT SEEDING AND LANDSCAPING 12. REMOVE TEMPORARY EROSION CONTROL MEASURES AFTER SEEDING AREAS HAVE ESTABLISHED THEMSELVES AND SITE IMPROVEMENTS ARE COMPLETE. SMOOTH AND REVEGETATE ALL DISTURBED AREAS. 13. ALL DRAINAGE STRUCTURES WILL BE CONSTRUCTED AND STABILIZED PRIOR TO HAVING RUNOFF DIRECTED TO THEM.
- 14. FINISH PAVING ALL ROADWAYS. 15. LOT DISTURBANCE OTHER THAN THAT SHOWN ON THE APPROVED PLANS SHALL NOT COMMENCE UNTIL THE ROADWAY HAS THE CRUSHED STONE COURSE TO DESIGN ELEVATION/REQUIRED COMPACTION AND THE ASSOCIATED DRAINAGE IS COMPLETE AND STABLE



WINTER MAINTENANCE

1. ALL DISTURBED AREAS THAT DO NOT HAVE AT LEAST 85% VEGETATIVE COVERAGE PRIOR TO OCTOBER 15TH, SHALL BE STABILIZED BY APPLYING MULCH AT A RATE OF 3-4 TONS PER ACRE. ALL SIDE SLOPES, STEEPER THAN 4:1, THAT ARE NOT DIRECTED TO SWALES OR DETENTION BASINS, SHALL BE LINED WITH BIODEGRADABLE PHOTODEGRADABLE "JUTE MATTING" (EXCELSIOR'S CURLEX II OR EQUAL). ALL OTHER SLOPES SHALL BE MULCHED AND TACKED AT A RATE OF 3-4 TONS PER ACRE. THE APPLICATION OF MULCH AND/OR JUTE MATTING SHALL NOT OCCUR OVER EXISTING SNOW COVER. IF THE SITE IS ACTIVE AFTER NOVEMBER 15TH, ANY SNOW THAT ACCUMULATES ON DISTURBED AREAS SHALL BE REMOVED. PRIOR TO SPRING THAW ALL AREAS WILL BE STABILIZED, AS DIRECTED ABOVE

2. ALL SWALES THAT DO NOT HAVE FULLY ESTABLISHED VEGETATION SHALL BE EITHER LINED WITH TEMPORARY JUTE MATTING OR TEMPORARY STONE CHECK DAMS (APPROPRIATELY SPACED). STONE CHECK DAMS WILL BE MAINTAINED THROUGHOUT THE WINTER MONTHS. IF THE SWALES ARE TO BE MATTED WITH PERMANENT LINERS OR RIPRAP WITH ENGINEERING FABRIC, THIS SHALL BE COMPLETED PRIOR TO WINTER SHUTDOWN OR AS SOON AS THEY ARE PROPERLY GRADED AND SHAPED.

3. PRIOR TO OCT. 15TH ALL ROADWAY AND PARKING AREAS SHALL BE BROUGHT UP TO AND THROUGH THE BANK RUN GRAVEL APPLICATION. IF THESE AREAS' ELEVATIONS ARE PROPOSED TO REMAIN BELOW THE PROPOSED SUBGRADE ELEVATION. THE SUBGRADE MATERIAL SHALL BE ROUGHLY CROWNED AND A 3" LAYER OF CRUSHED GRAVEL SHALL BE PLACED AND COMPACTED. THIS WILL ALLOW THE SUBGRADE TO SHED RUNOFF AND WILL REDUCE ROADWAY EROSION. THIS CRUSHED GRAVEL DOES NOT HAVE TO CONFORM TO NH DOT 304.3, BUT SHALL HAVE BETWEEN 15-25% PASSING ACCUMULATED SNOW SHALL BE REMOVED FROM ALL ROADWAY AND PARKING AREAS.

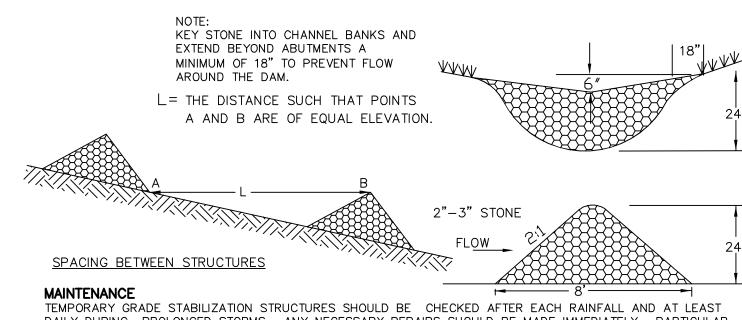
4. AFTER OCTOBER 15TH, THE END OF NEW HAMPSHIRE'S AVERAGE GROWING SEASON, NO ADDITIONAL LOAM SHALL BE SPREAD ON SIDE SLOPES AND SWALES. THE STOCKPILES THAT WILL BE LEFT UNDISTURBED UNTIL SPRING SHALL BE SEEDED BY THIS DATE. AFTER OCTOBER 15TH, ANY NEW OR DISTURBED PILES SHALL BE MULCHED AT A RATE OF 3-4 TONS PER ACRE. ALL STOCKPILES THAT WILL REMAIN THROUGHOUT THE WINTER SHALL BE SURROUNDED WITH SILT FENCING.

SEEDING SPECIFICATIONS

- 1. GRADING AND SHAPING
- A. SLOPES SHALL NOT BE STEEPER THAN 2:1;3:1 SLOPES OR FLATTER ARE PREFERRED. WHERE MOWING WILL BE DONE, 3:1 SLOPES OR FLATTER ARE RECOMMENDED.
- 2. SEEDBED PREPARATION A. SURFACE AND SEEPAGE WATER SHOULD BE DRAINED OR DIVERTED FROM THE SITE TO PREVENT DROWNING OR WINTER KILLING OF THE PLANTS.
- B. STONES LARGER THAN 4 INCHES AND TRASH SHOULD BE REMOVED BECAUSE THEY INTERFERE WITH SEEDING AND FUTURE MAINTENANCE OF THE AREA. WHERE FEASIBLE, THE SOIL SHOULD BE TILLED TO A DEPTH OF ABOUT 4 INCHES TO PREPARE A SEEDBED AND MIX FERTILIZER AND LIME INTO THE SOIL. THE SEEDBED SHOULD BE LEFT IN REASONABLY FIRM AND SMOOTH CONDITION. THE LAST TILLAGE OPERATION SHOULD BE PERFORMED ACROSS THE SLOPE WHEREVER PRACTICAL.
- 3. ESTABLISHING A STAND A. LIME AND FERTILIZER SHOULD BE APPLIED PRIOR TO OR AT THE TIME OF SEEDING AND INCORPORATED INTO THE SOIL
- KINDS AND AMOUNTS OF LIME AND FERTILIZER SHOULD BE BASED ON AN EVALUATION OF SOIL TESTS. WHEN A SOIL TEST IS NOT AVAILABLE, THE FOLLOWING MINIMUM AMOUNTS SHOULD BE APPLIED:
- NITROGEN(N), 50 LBS PER ACRE OR 1. 1 LBS PER 1,000 SQ.FT.
- PHOSPHATE(P205), 100 LBS PER ACRE OR 2. 2 LBS PER 1,000 SQ.FT.
- POTASH(K20), 100 LBS PER ACRE OR 2. 2 LBS PER 1,000 SQ.FT.

AGRICULTURAL LIMESTONE, 2 TONS PER ACRE OR 100 LBS PER 1,000 SQ. FT..


- (NOTE: THIS IS THE EQUIVALENT OF 500 LBS PER ACRE OF 10-20-20 FERTILIZER OR 1,000 LBS PER ACRE OF 5-10-10.)
- B. SEED SHOULD BE SPREAD UNIFORMLY BY THE METHOD MOST APPROPRIATE FOR THE SITE. METHODS INCLUDE BROADCASTING, DRILLING AND HYDROSEEDING. WHERE BROADCASTING IS USED, COVER SEED WITH .25 INCH OF SOIL OR LESS, BY CULTIPACKING OR RAKING.
- C. REFER TO TABLE(G-E1 THIS SHEET) FOR APPROPRIATE SEED MIXTURES AND TABLE(H-E1 THIS SHEET) FOR RATES OF SEEDING. ALL LEGUMES (CROWN VETCH, BIRDS FOOT TREFOIL, AND FLAT PEA) MUST BE INOCULATED
- D. WHEN SEEDED AREAS ARE MULCHED, PLANTINGS MAY BE MADE FROM EARLY SPRING TO EARLY OCTOBER. WHEN SEEDED AREAS ARE NOT MULCHED, PLANTINGS SHOULD BE MADE FROM EARLY SPRING TO MAY 20 OR FROM AUGUST 10 TO SEPTEMBER 1.
- A. HAY, STRAW, OR OTHER MULCH, WHEN NEEDED, SHOULD BE APPLIED IMMEDIATELY AFTER SEEDING.
- B. MULCH WILL BE HELD IN PLACE USING APPROPRIATE TECHNIQUES FROM THE BEST MANAGEMENT PRACTICE FOR MULCHING. HAY OR STRAW MULCH SHALL BE PLACED AT A RATE OF 90 LBS PER 1000 SQ. FT.
- 5. MAINTENANCE TO ESTABLISH A STAND
- A. PLANTED AREA SHOULD BE PROTECTED FROM DAMAGE BY FIRE, GRAZING, TRAFFIC, AND DENSE WEED GROWTH. B. FERTILIZATION NEEDS SHOULD BE DETERMINED BY ONSITE INSPECTIONS. SUPPLEMENTAL FERTILIZER IS USUALLY THE KEY TO FULLY COMPLETE THE ESTABLISHMENT OF THE STAND BECAUSE MOST PERENNIAL STAKE 2 TO 3 YEARS TO
- C. IN WATERWAYS, CHANNELS, OR SWALES WHERE UNIFORM FLOW CONDITIONS ARE ANTICIPATED, OCCASIONAL
- MOWING MAY BE NECESSARY TO CONTROL GROWTH OF WOODY VEGETATION.



DAILY DURING PROLONGED STORMS. ANY NECESSARY REPAIRS SHOULD BE MADE IMMEDIATELY. PARTICULAR ATTENTION SHOULD BE GIVEN TO END RUN AND EROSION AT THE DOWNSTREAM TOE OF THE STRUCTURE. WHEN THE STRUCTURES ARE REMOVED, THE DISTURBED PORTION SHOULD BE BROUGHT TO THE EXISTING CHANNEL GRADE AND THE AREAS PREPARED, SEEDED AND MULCHED. WHILE THIS PRACTICE IS NOT INTENDED TO BE USED PRIMARILY FOR SEDIMENT TRAPPING, SOME SEDIMENT WILL ACCUMULATE BEHIND THE STRUCTURES. SEDIMENT SHALL BE REMOVED FROM BEHIND THE STRUCTURES WHEN IT HAS ACCUMULATED TO ONE HALF OF THE ORIGINAL HEIGHT OF THE STRUCTURE.

AFTER VEGETATION HAS STABILIZED, THESE TEMPORARY STRUCTURES SHALL BE REMOVED WITH SPECIAL CARE

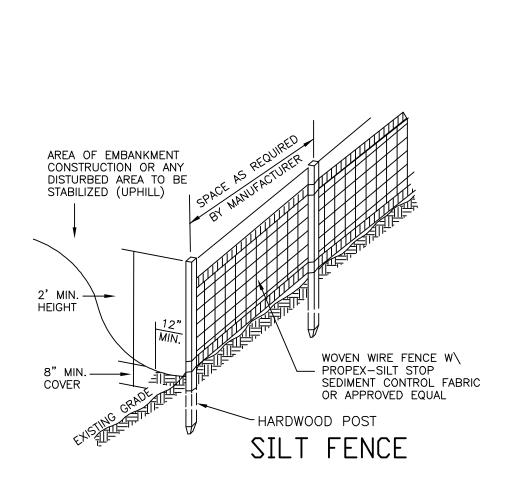TEMPORARY STONE CHECK DAM



CONSTRUCTION SPECIFICATIONS

MINIMUM OF 16" INTO THE GROUND.

DEVELOP IN THE SILT FENCE AND PROPERLY DISPOSED OF.

THE REMOVAL SHALL BE SMOOTHED AND RE-VEGETATED

BY-PASSING.

MAINTENANCE

Mix material should consist of 30-50% large (1-3") particles. The organic matter content should be 25%-65%, dry weight basis. The organic matter may originate from a variety of vegetative sources, but needs to be fibrous and elongated. The mix shall be free of silt clay, fine sand, refuse and contaminants or any material toxic to plant growth. Erosion Control Mix berms are effective filters for overland flow conditions and should not be used to filter concentrated flow such as that found in drainage

No.9900

ditchs, streams, etc. Erosion Control Mix Berm

CREEPING RED FESCUE

F. TALL FESCUE 1

KENTUCKY BLUEGRASS 1/2

CURRENT VARIETIES AND SEEDING RATES.

Section A - A

Bare or vegetated

Erosion Control Mix Berm

Placed perpendicular to slop

POUNDS PER <u>MIXTURE</u> PER ACRE 1,000 Sq. Ft A. TALL FESCUE CREEPING RED FESCUE 0.45 B. TALL FESCUE CREEPING RED FESCUE 0.25 0.35 CROWN VETCH FLAT PEA 40 OR 55 0.95 OR 1.35 TALL FESCUE BIRDS FOOT TREFOIL D. TALL FESCUE FLAT PEA

SEEDING RATES TABLE H-E1

2. IF THE FABRIC ON A SILT FENCE SHOULD DECOMPOSE OR BECOME INEFFECTIVE DURING THE EXPECTED LIFE OF THE FENCE, THE FABRIC SHALL BE REPLACED PROMPTLY. 3. SEDIMENT DEPOSITS SHOULD BE INSPECTED AFTER EVERY STORM EVENT. THE DEPOSITS SHOULD BE REMOVED WHEN THEY REACH APPROXIMATELY ONE HALF THE HEIGHT OF THE 4. SEDIMENT DEPOSITS THAT ARE REMOVED OR LEFT IN PLACE AFTER THE FABRIC HAS BEEN REMOVED SHALL BE GRADED TO CONFORM WITH THE EXISTING TOPOGRAPHY AND VEGETATED.

SEEDING GUIDE TABLE G-E1

1. WOVEN WIRE FENCE TO BE FASTENED SECURELY TO FENCE POSTS WITH WIRE TIES OR

STAPLES AND FILTER CLOTH SHALL BE FASTENED TO WOVEN WIRE EVERY 24" AT TOP MID

POSTS SHALL BE A MINIMUM 48" LONG, SPACED A MAXIMUM 10' APART, AND DRIVEN A

AND BOTTOM SECTIONS AND BE EMBEDDED INTO GROUND A MINIMUM OF 8". 2. THE FENCE

3. WHEN TWO SECTIONS OF FILTER CLOTH ADJOIN EACH OTHER, THE ENDS OF THE FABRIC

SHALL BE OVERLAPPED BY SIX INCHES, FOLDED AND STAPLED TO PREVENT SEDIMENT FROM

4. MAINTENANCE SHALL BE PERFORMED AS NEEDED AND SEDIMENT REMOVED WHEN "BULGES"

5. PLACE THE ENDS OF THE SILT FENCE UP CONTOUR TO PROVIDE FOR SEDIMENT STORAGE.

COLLECTED SHALL BE DISPOSED AS DIRECTED BY THE ENGINEER. THE AREA DISTURBED BY

1. SILT FENCES SHALL BE INSPECTED IMMEDIATELY AFTER FACH RAINFALL AND AT LEAST

DAILY DURING PROLONGED RAINFALL. ANY REPAIRS THAT ARE REQUIRED SHALL BE MADE

6. SILT FENCES SHALL BE REMOVED WHEN NO LONGER NEEDED AND THE SEDIMENT

USE	SEEDING MIXTURE 1/	DROUGHTY	WELL DRAINED	MODERATELY WELL DRAINED	POORLY DRAINED
STEEP CUTS AND FILLS, BORROW	A B	FAIR POOR	GOOD GOOD	GOOD FAIR	FAIR FAIR
AND DISPOSAL AREAS	C D E	POOR FAIR FAIR	GOOD FAIR EXCELLENT	GOOD EXCELLENT	GOOD EXCELLENT POOR
WATERWAYS, EMERGENCY SPILLWAYS, AND OTHER	A C	GOOD GOOD	GOOD EXCELLENT	GOOD EXCELLENT	FAIR FAIR
CHANNELS WITH FLOWING WATER.	D	GOOD	EXCELLENT	EXCELLENT	FAIR
LIGHTLY USED PARKING LOTS, ODD AREAS, UNUSED LANDS, AND	A B C	GOOD GOOD GOOD	GOOD GOOD EXCELLENT	GOOD FAIR EXCELLENT	FAIR POOR FAIR
LOW INTENSITY USE RECREATION SITES.	D	FAIR	GOOD	GOOD	EXCELLENT
PLAY AREAS AND ATHLETIC FIELDS. (TOPSOIL IS ESSENTIAL FOR GOOD TURF.)	F G	FAIR FAIR	EXCELLENT EXCELLENT	EXCELLENT EXCELLENT	<u>2/</u> <u>2/</u>
GRAVEL PIT, SEE NH-PM SAND AND GRAVEL PITS.	-24 IN APPENI	DIX FOR RECOM	MENDATION REG	ARDING RECLAMA	TION OF

1/ REFER TO SEEDING MIXTURES AND RATES IN TABLE 7-36. POORLY DRAINED SOILS ARE NOT DESIRABLE FOR USE AS PLAYING AREA AND ATHLETIC FIELDS. NOTE: TEMPORARY SEED MIX FOR STABILIZATION OF TURF

1000 S.F. AND SHALL BE PLACED PRIOR TO OCT. 15, IF

PERMANENT SEEDING NOT YET COMPLETE.

SHALL BE WINTER RYE OR DATS AT A RATE OF 2.5 LBS. PER


REVISED PER REVIEW 3-12-24 DATE: **REVISIONS:**

1/ FOR HEAVY USE ATHLETIC FIELDS CONSULT THE UNIVERSITY OF NEW HAMPSHIRE COOPERATIVE EXTENSION TURF SPECIALIST FOR

3.60

EROSION & SEDIMENT CONTROL DETAILS


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PROJ. N0:	NH-1490	SHEET NO.	26	

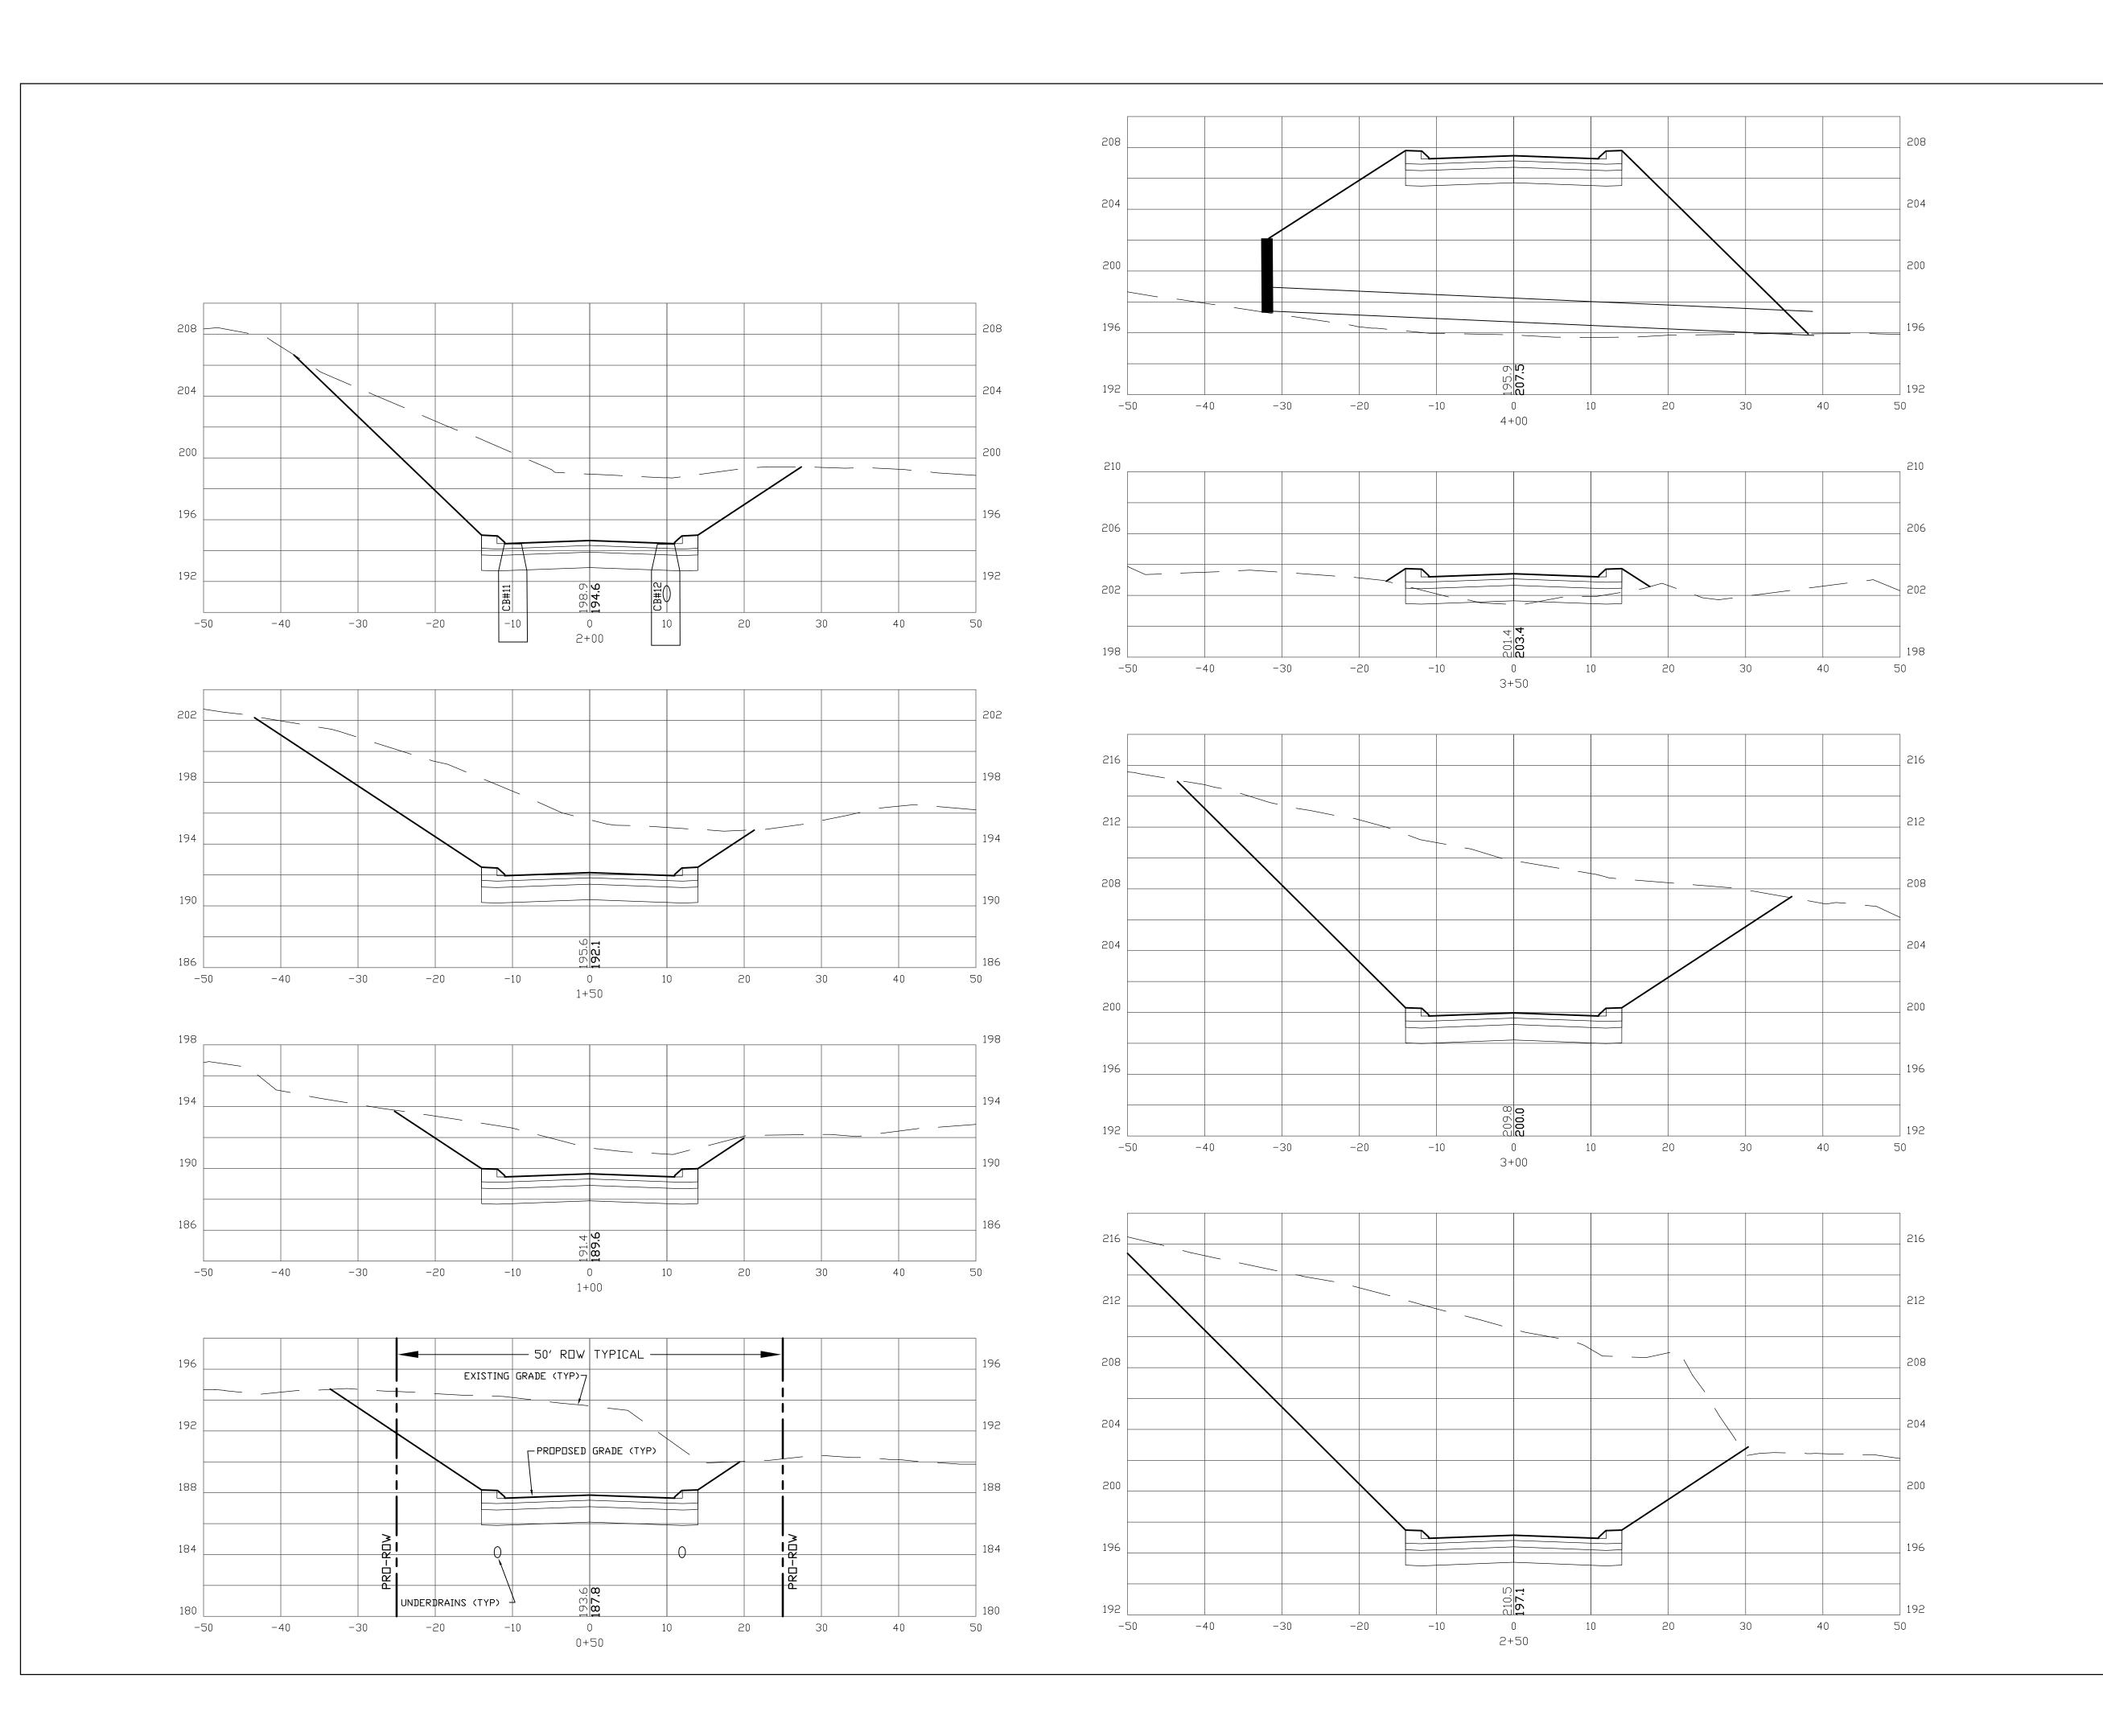

JOSEPH FALZONE 7B EMERY LANE STRATHAM, N.H. 03885



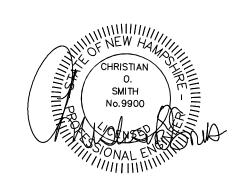
70 PORTSMOUTH AVE, THIRD FLOOR, SUITE 2 STRATHAM, N.H. 03885 PHONE: 603-583-4860, FAX. 603-583-4863



CROSS SECTION SCALES:
HORIZONTAL: 1"=10' VERTICAL: 1"=5'

ROAD CROSS SECTIONS X1


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JOSEPH FALZONE 7B EMERY LANE STRATHAM, N.H. 03885

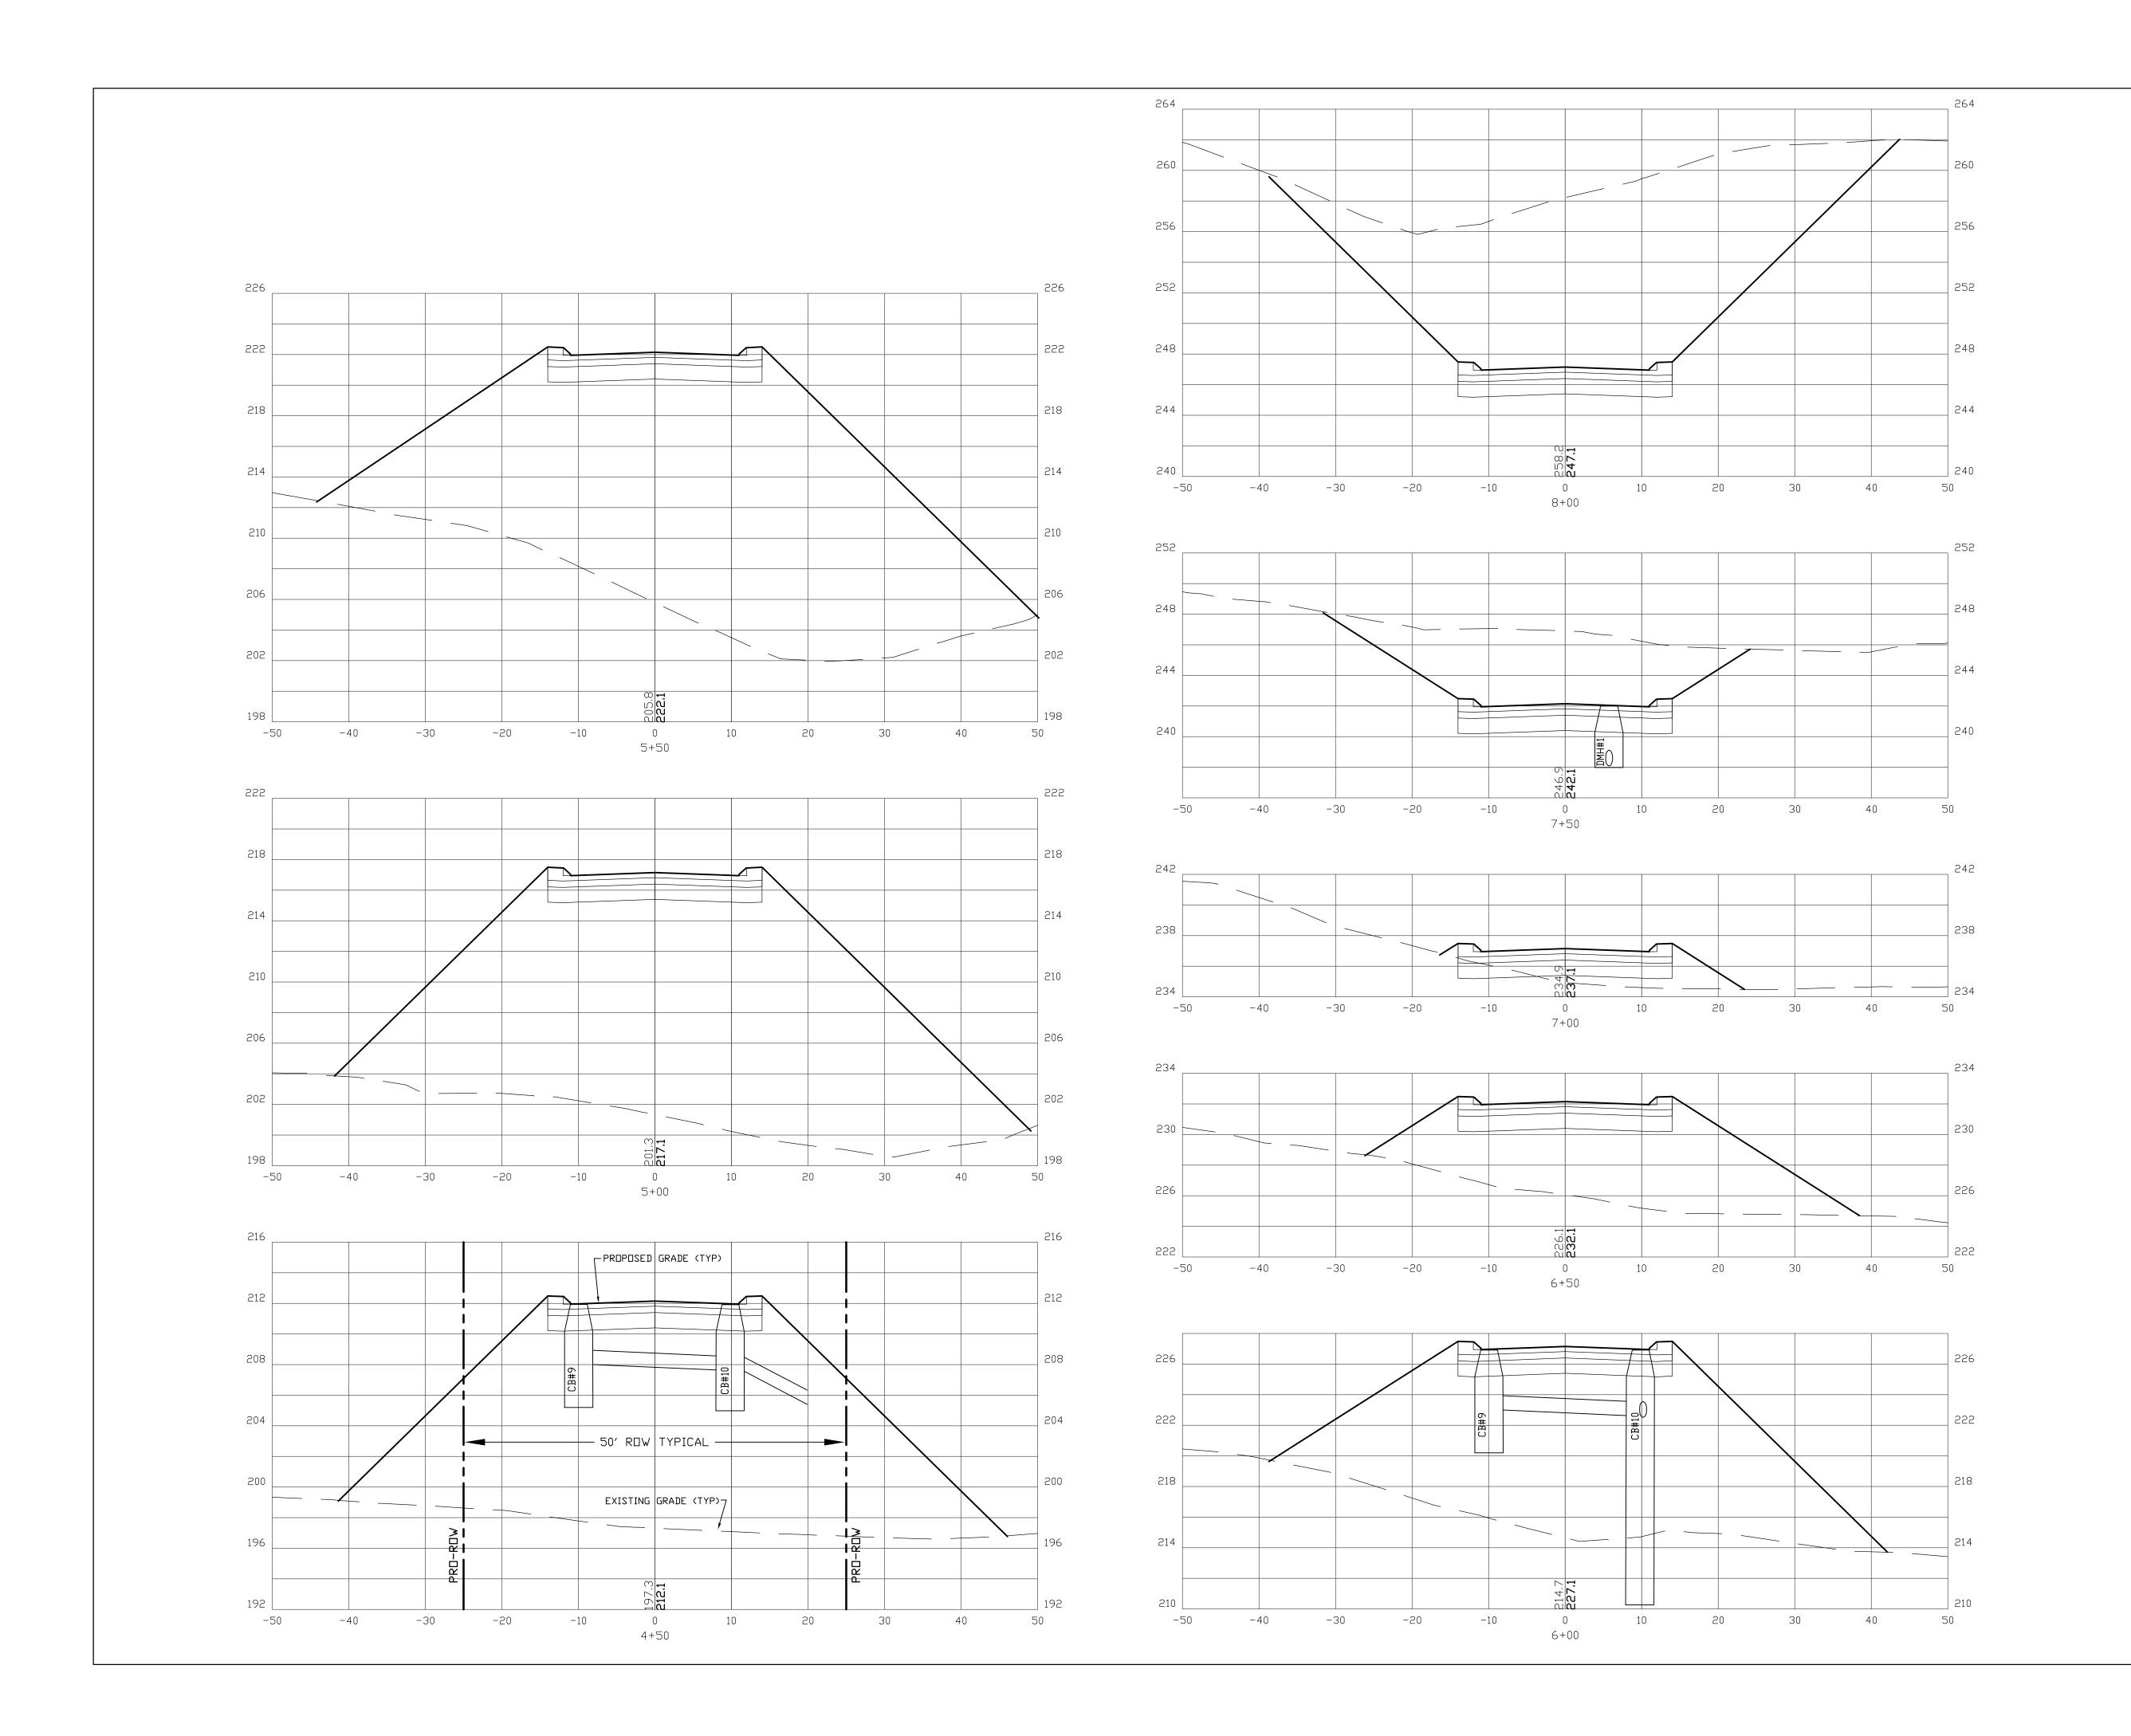


70 PORTSMOUTH AVE, THIRD FLOOR, SUITE 2 STRATHAM, N.H. 03885 PHONE: 603-583-4860, FAX. 603-583-4863



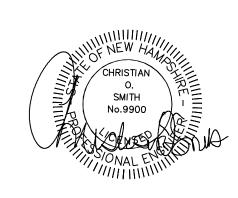CROSS SECTION SCALES:
HORIZONTAL: 1"=10' VERTICAL: 1"=5'

ROAD CROSS SECTIONS X2


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JOSEPH FALZONE 7B EMERY LANE STRATHAM, N.H. 03885

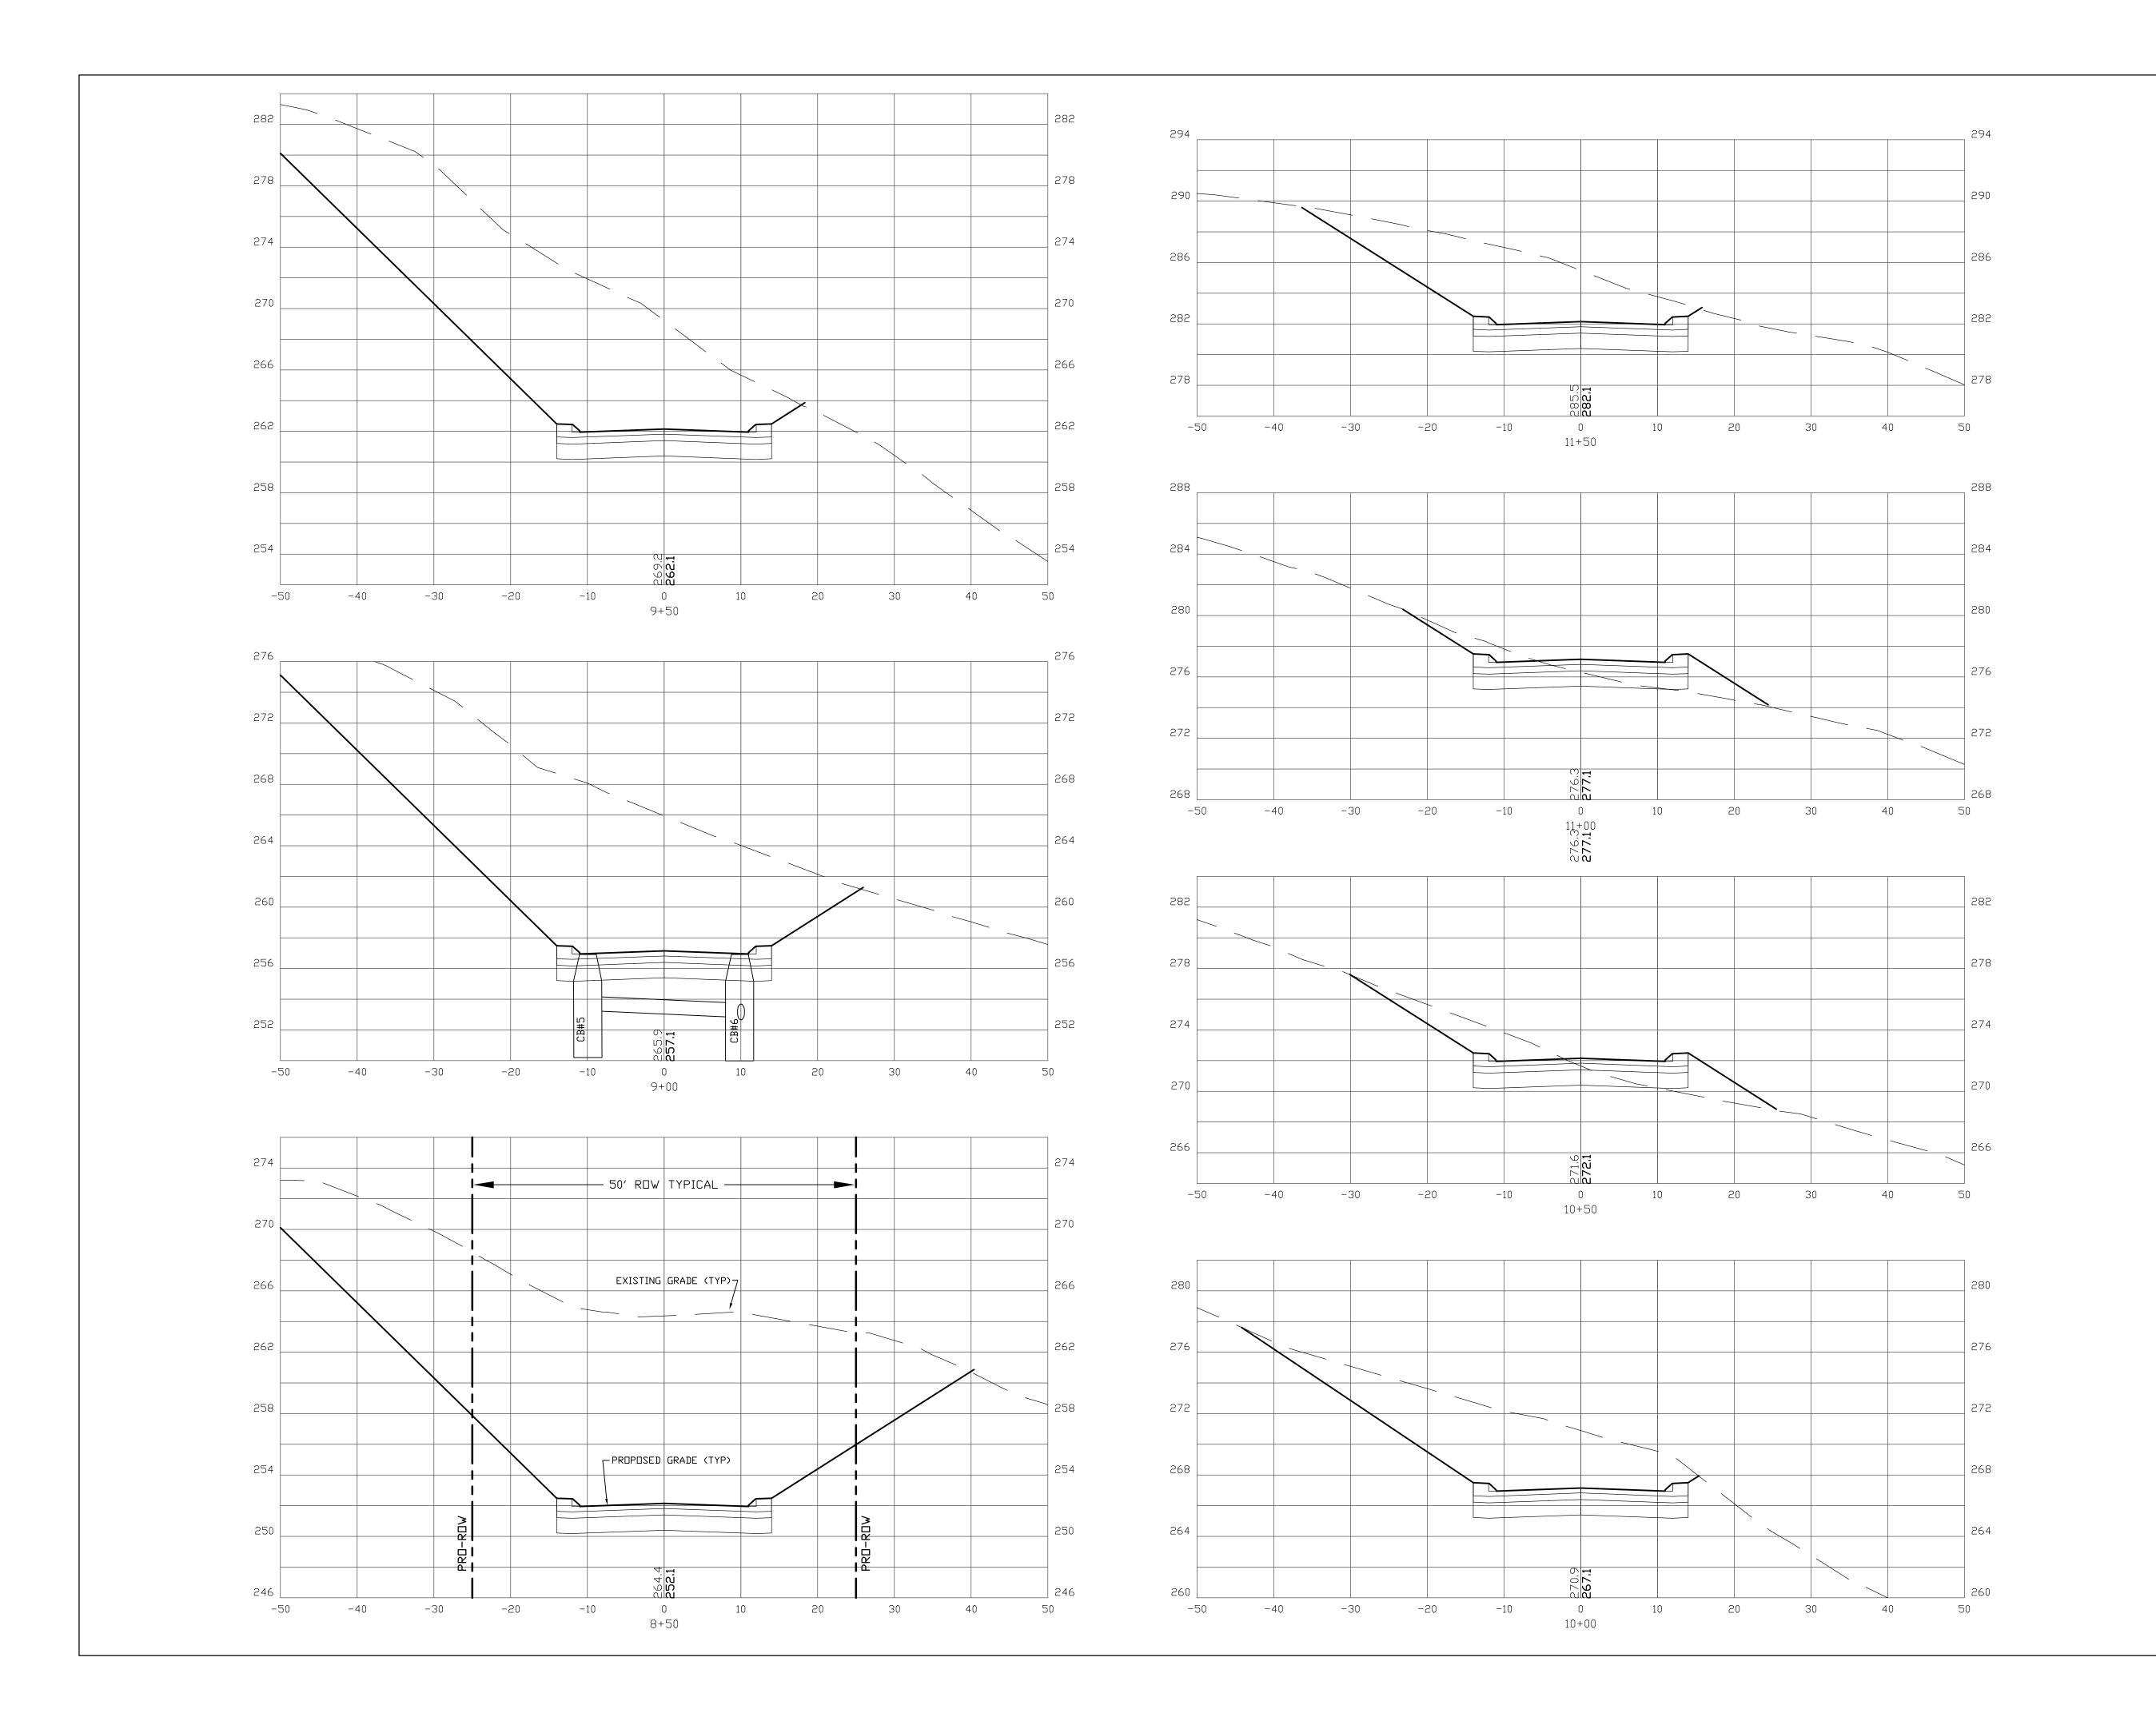


70 PORTSMOUTH AVE, THIRD FLOOR, SUITE 2 STRATHAM, N.H. 03885 PHONE: 603-583-4860, FAX. 603-583-4863



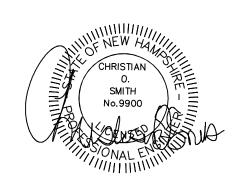CROSS SECTION SCALES:
HORIZONTAL: 1"=10' VERTICAL: 1"=5'

ROAD CROSS SECTIONS X3

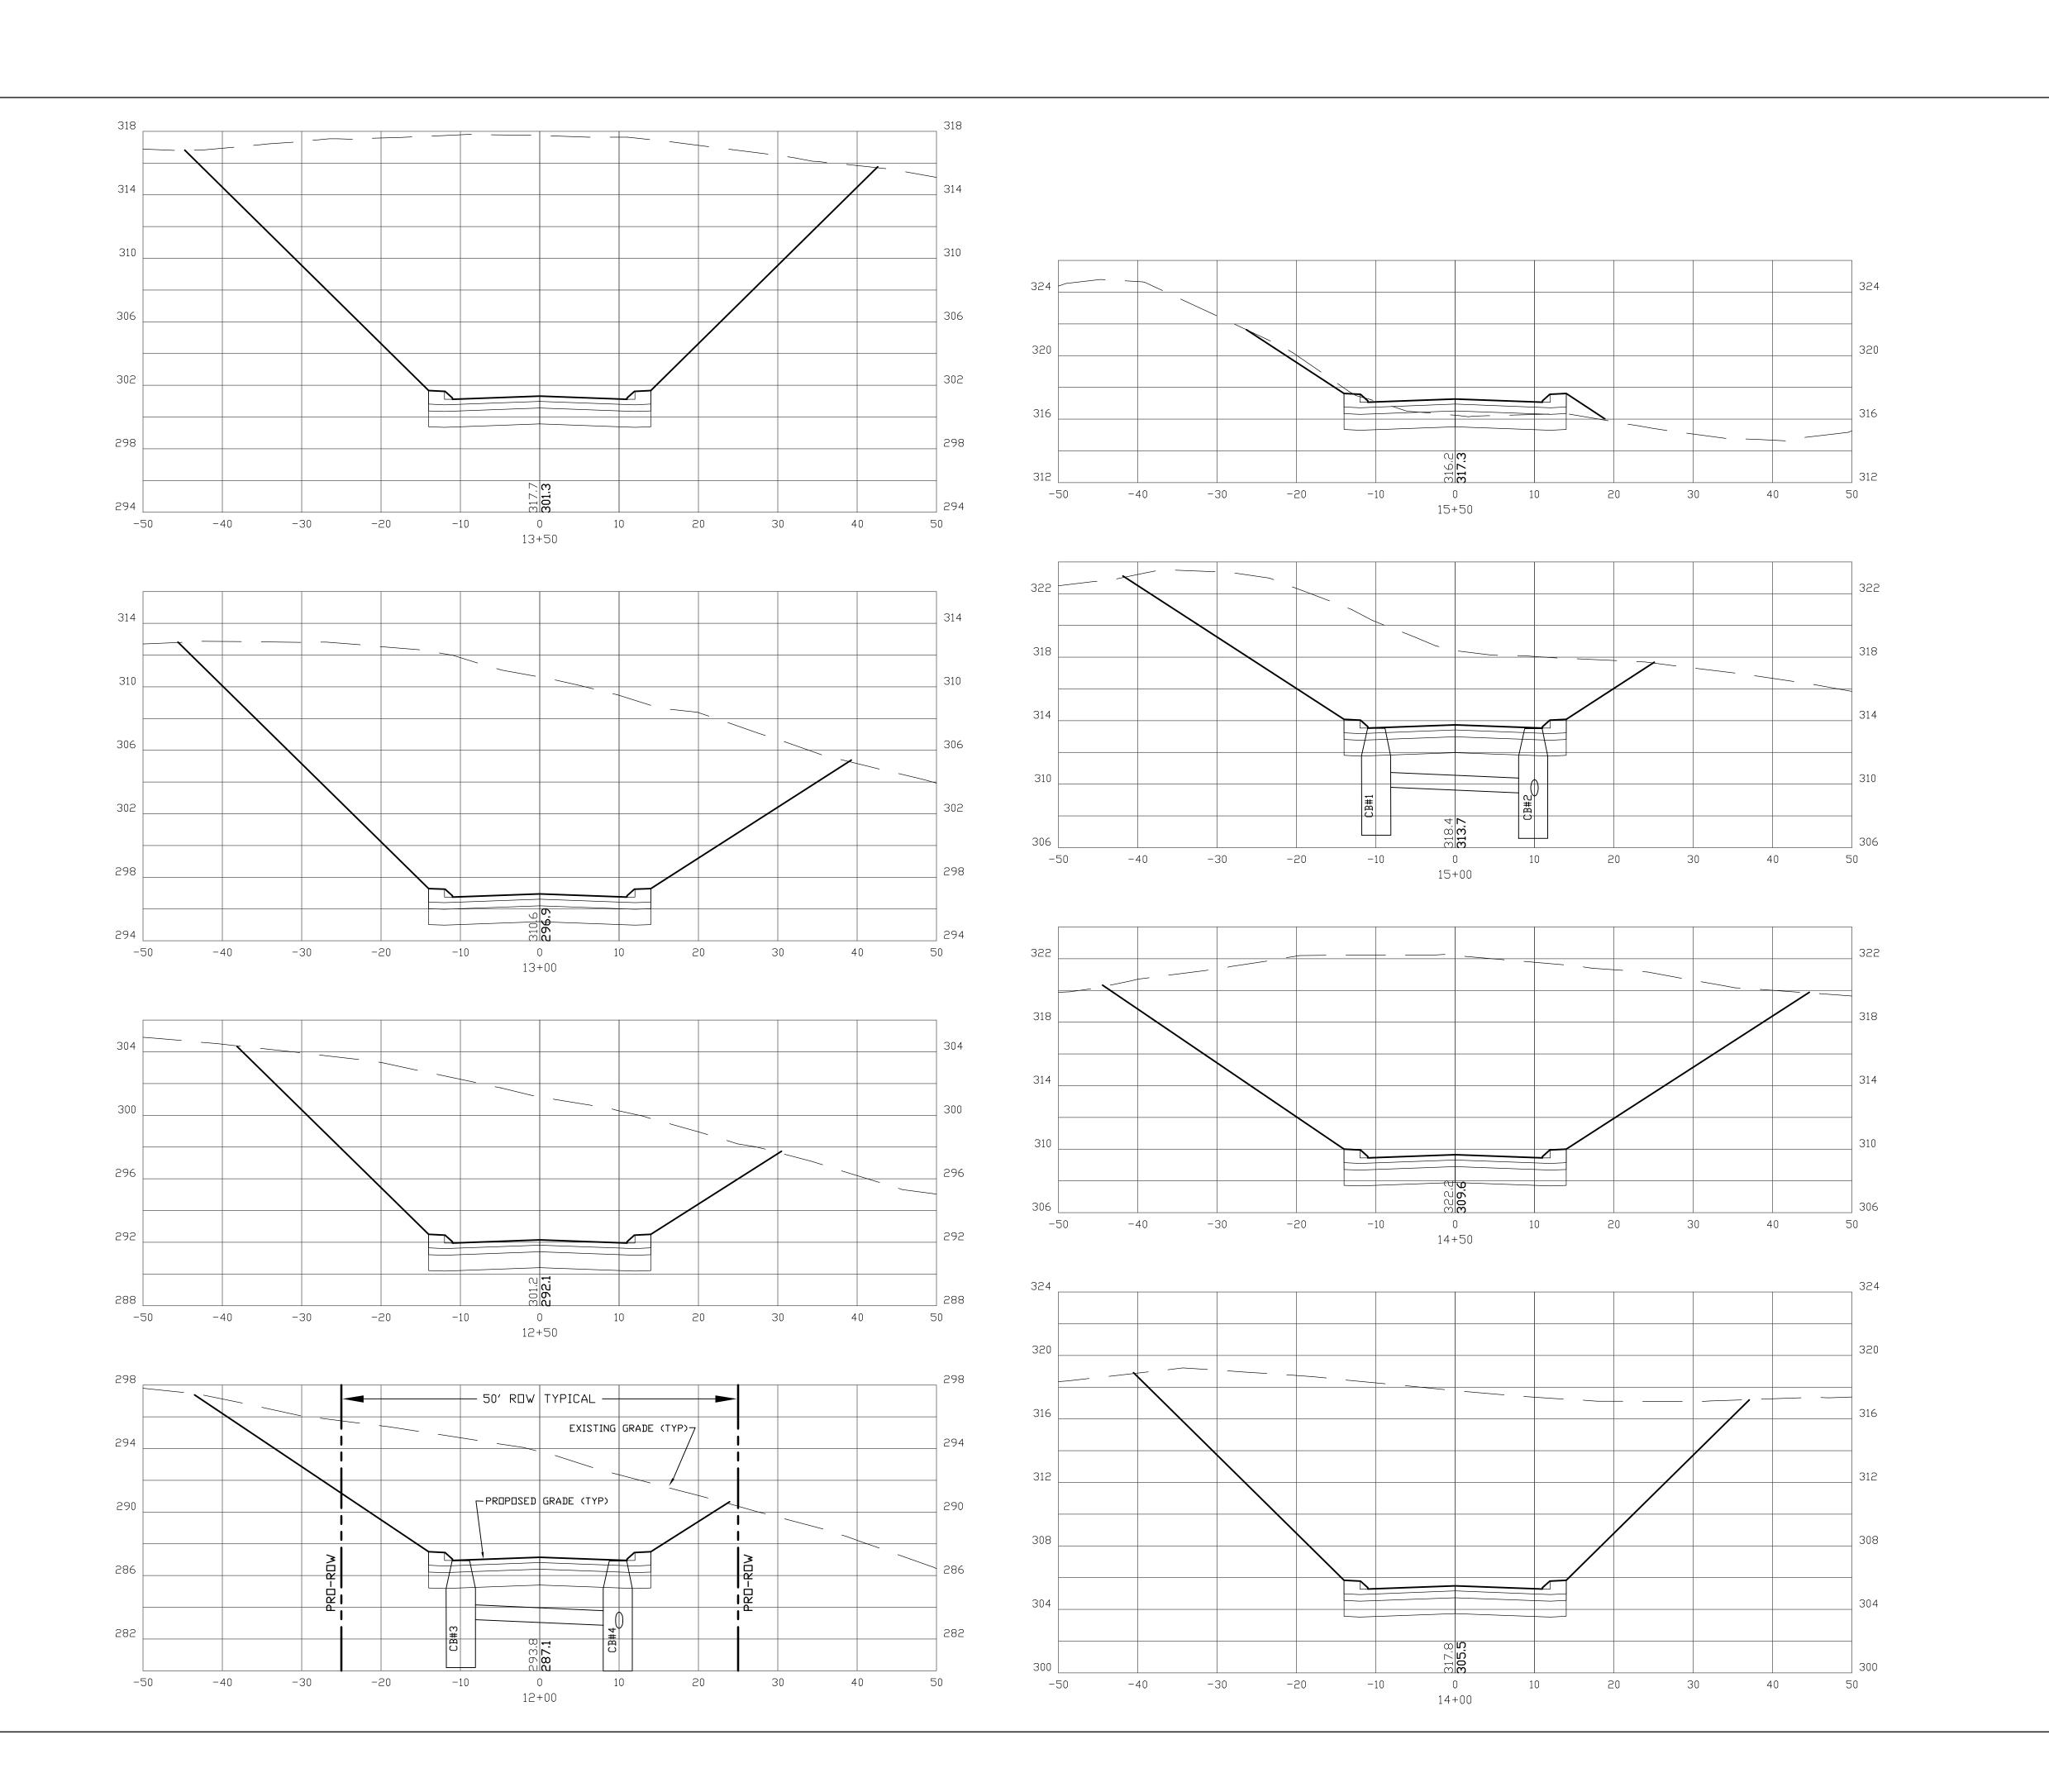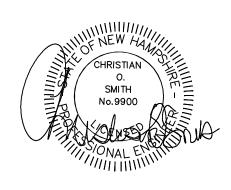
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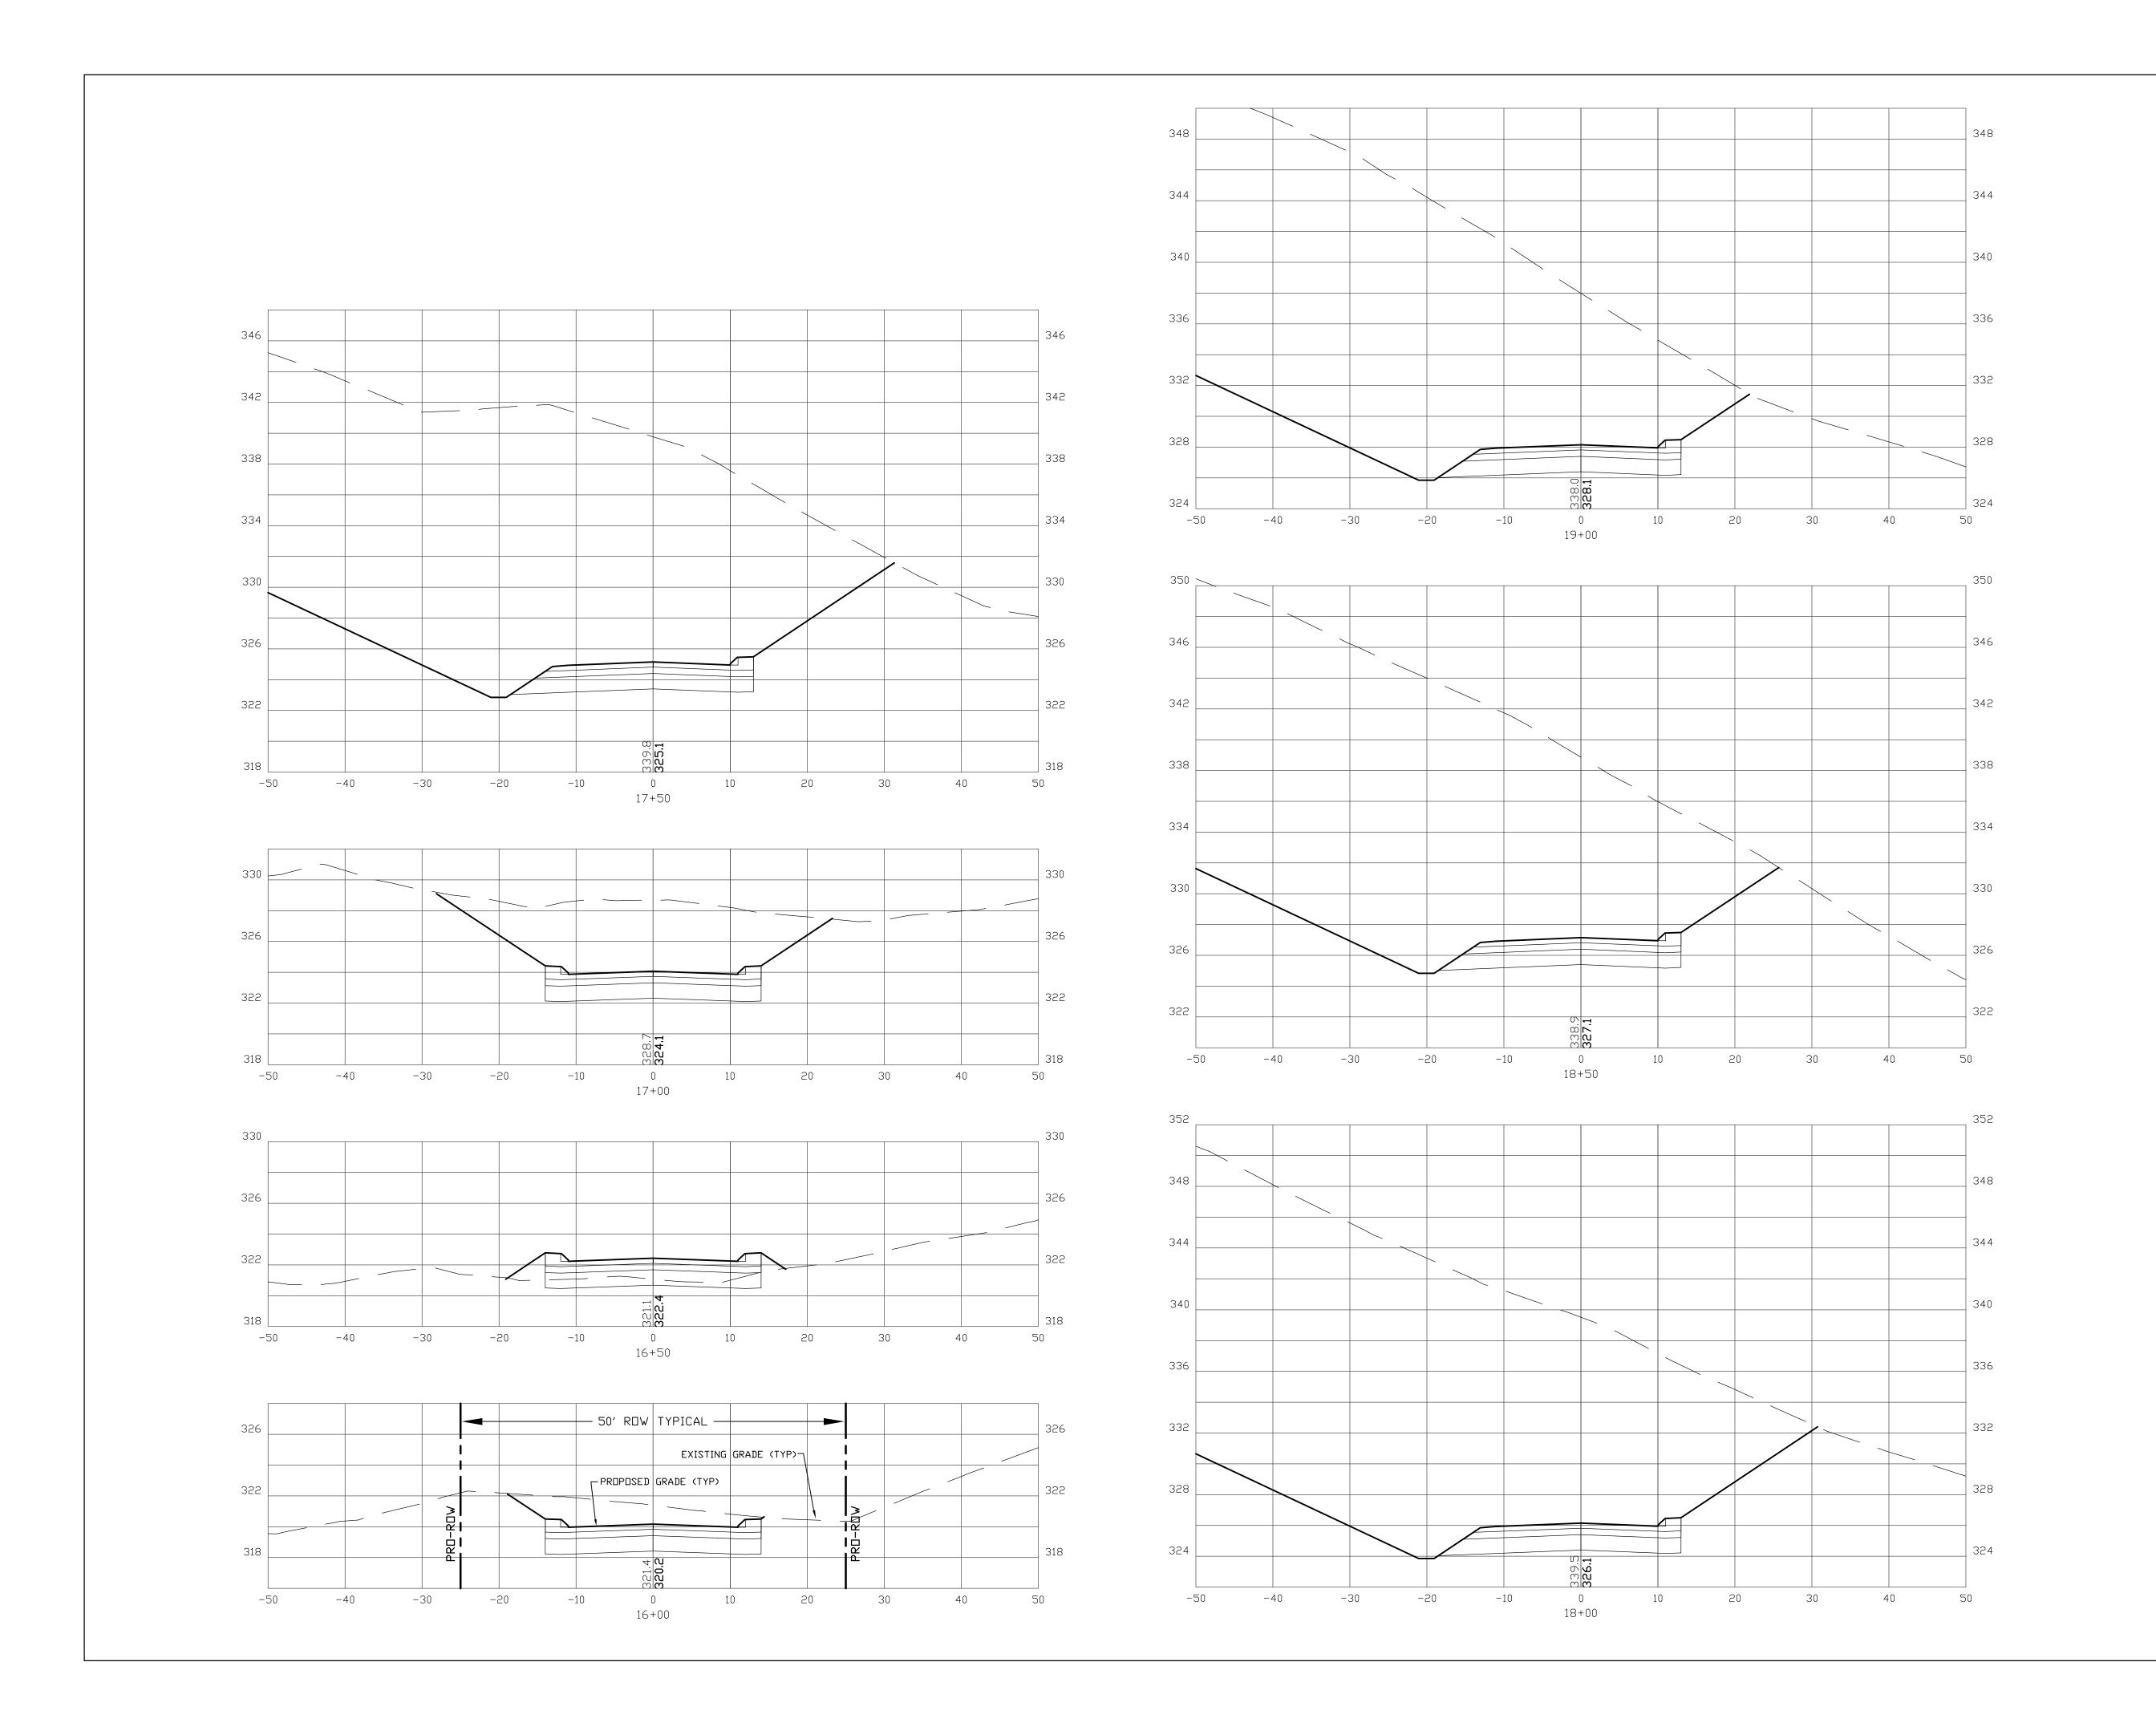
70 PORTSMOUTH AVE, THIRD FLOOR, SUITE 2 STRATHAM, N.H. 03885 PHONE: 603-583-4860, FAX. 603-583-4863



CROSS SECTION SCALES:
HORIZONTAL: 1"=10' VERTICAL: 1"=5'

ROAD CROSS SECTIONS X4

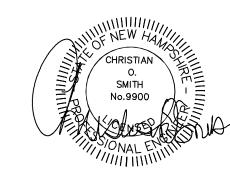
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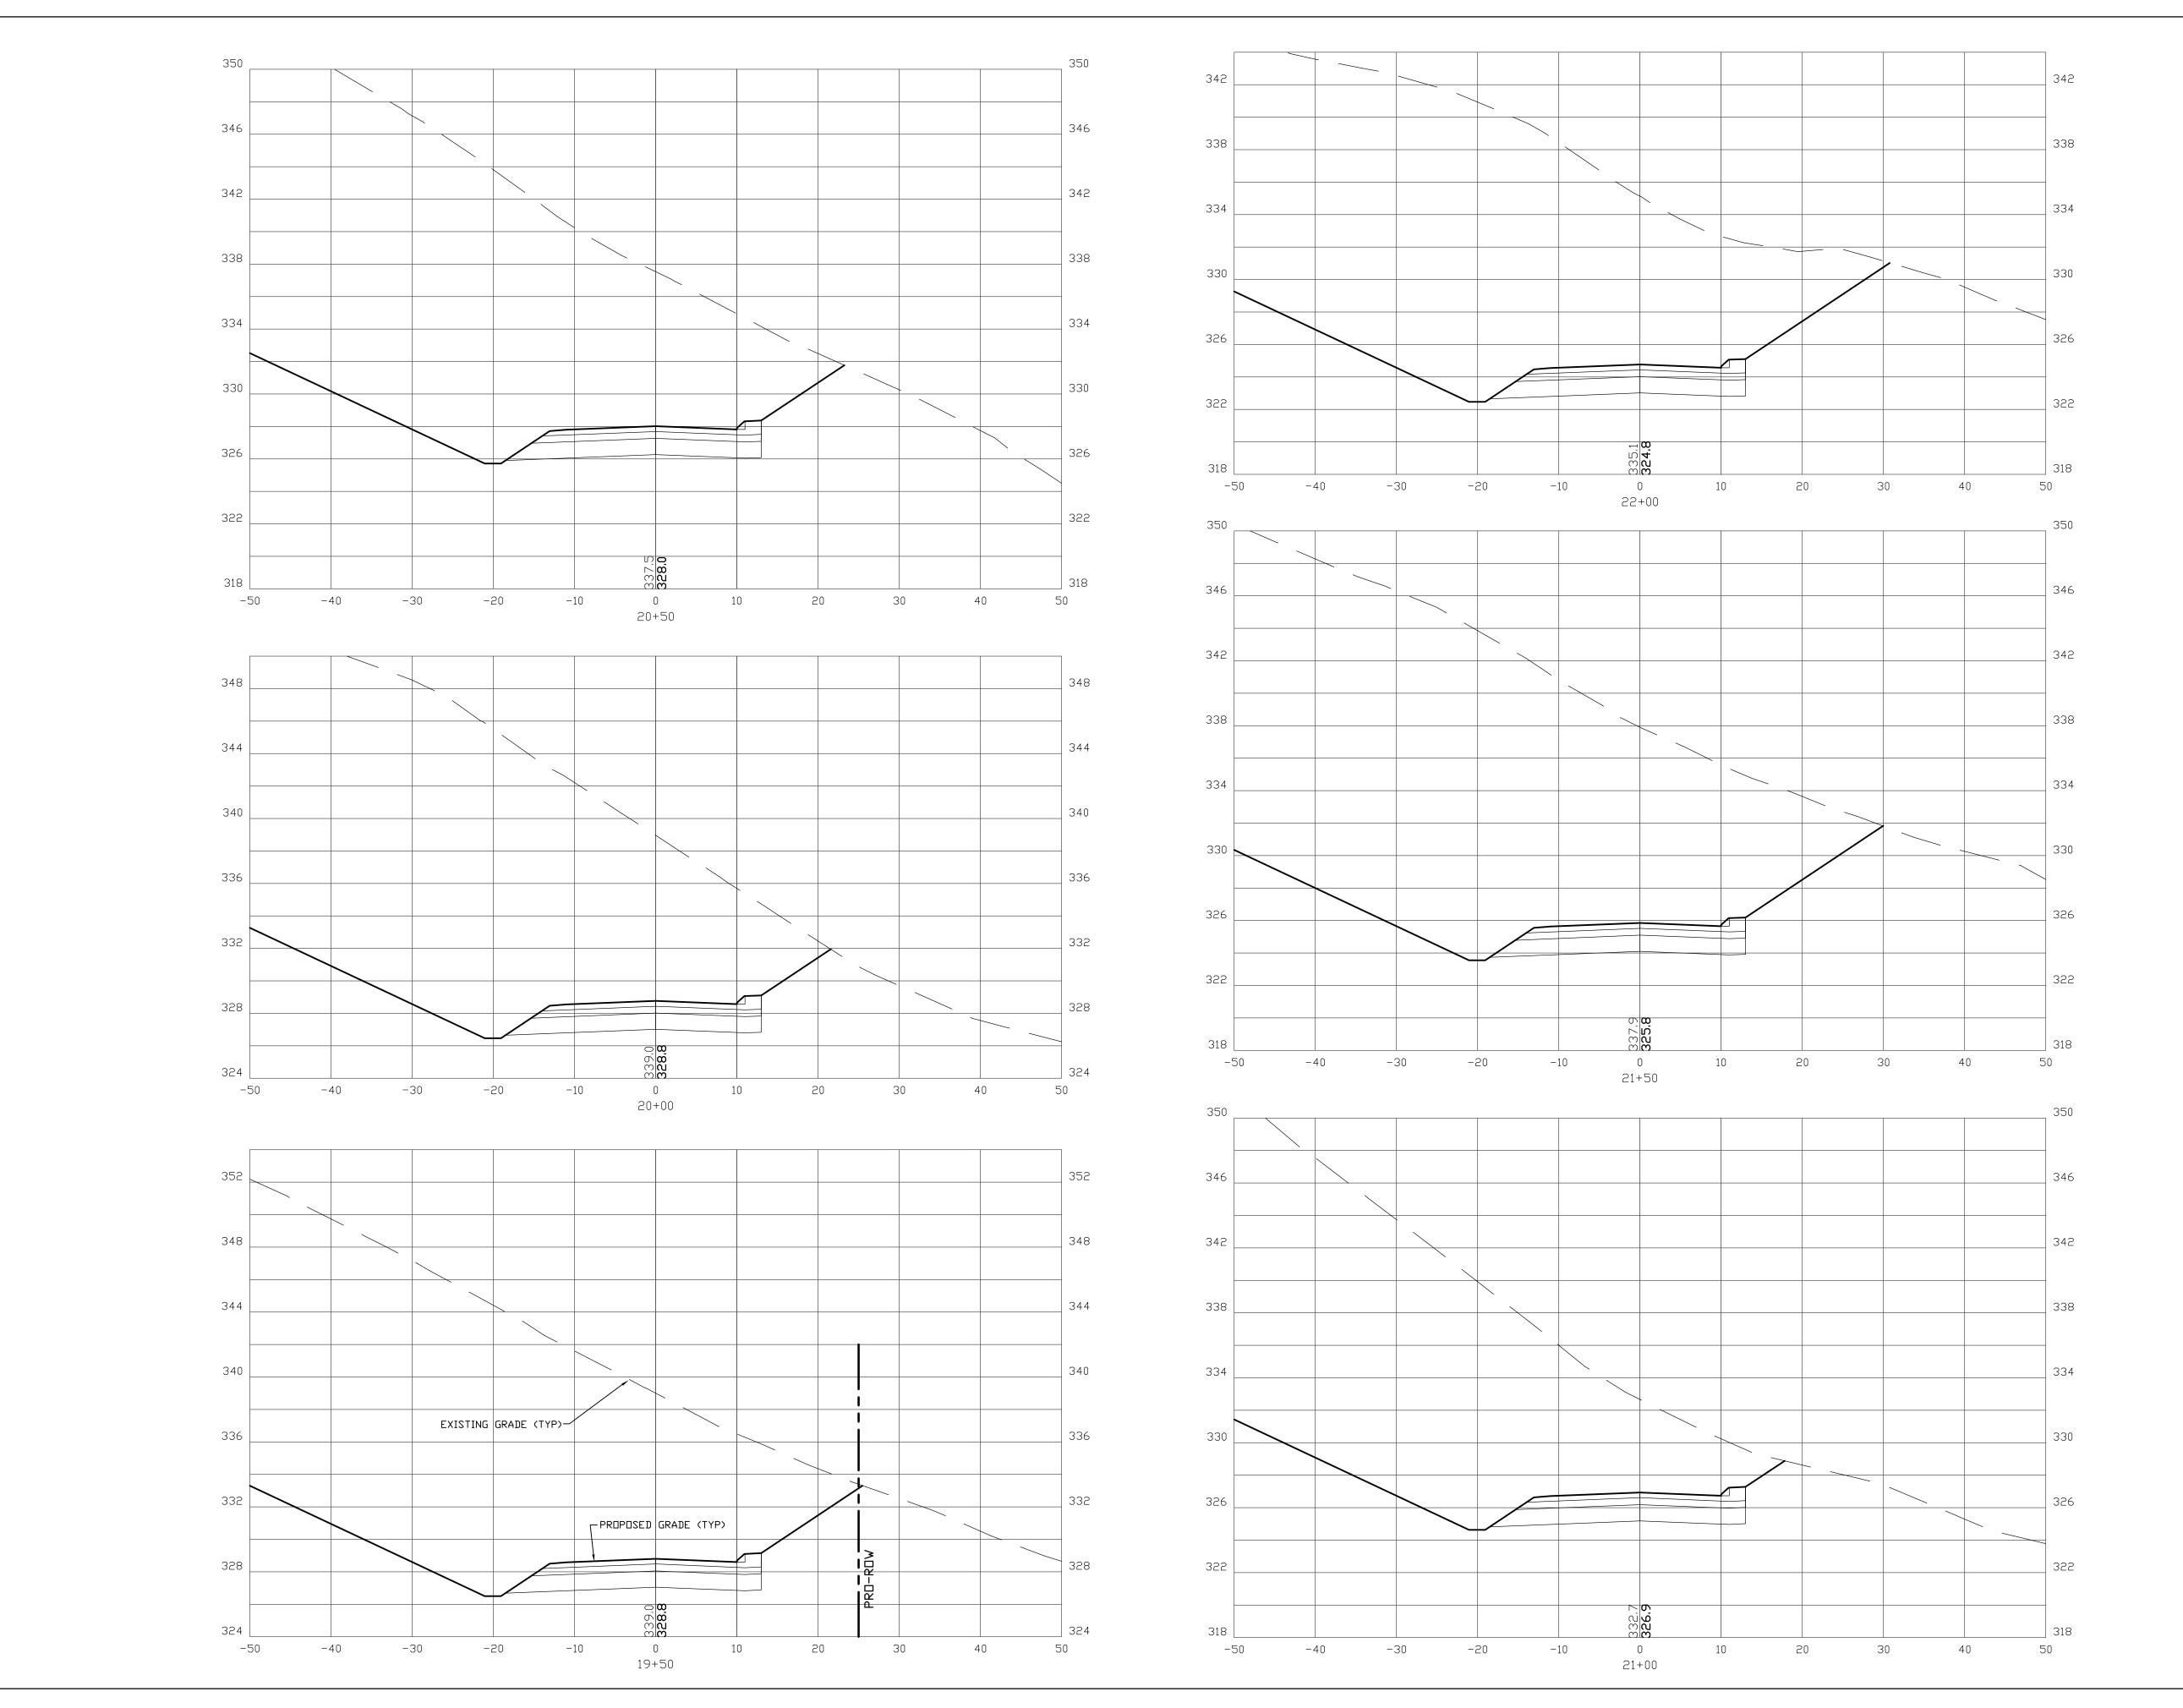
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CROSS SECTION SCALES:
HORIZONTAL: 1"=10' VERTICAL: 1"=5'

ROAD CROSS SECTIONS X5


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CROSS SECTION SCALES:
HORIZONTAL: 1"=10' VERTICAL: 1"=5'

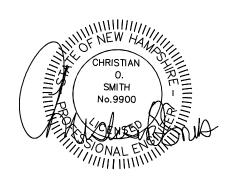ROAD CROSS SECTIONS X6

DATE:	MARCH 2024	SCALE	1" = 10'
PROJ. N0:	NH-1490	SHEET NO.	32